



MASTER DEVELOPMENT PLANS  
FOR  
SPACE COAST COMMERCE PARK  
@ PARKTOWNE  
CITY OF EDGEWATER, FL

PREPARED FOR:  
ONICX MANAGEMENT  
GROUP, LLC  
5600 MARINER STREET, SUITE 140  
TAMPA, FL 33609

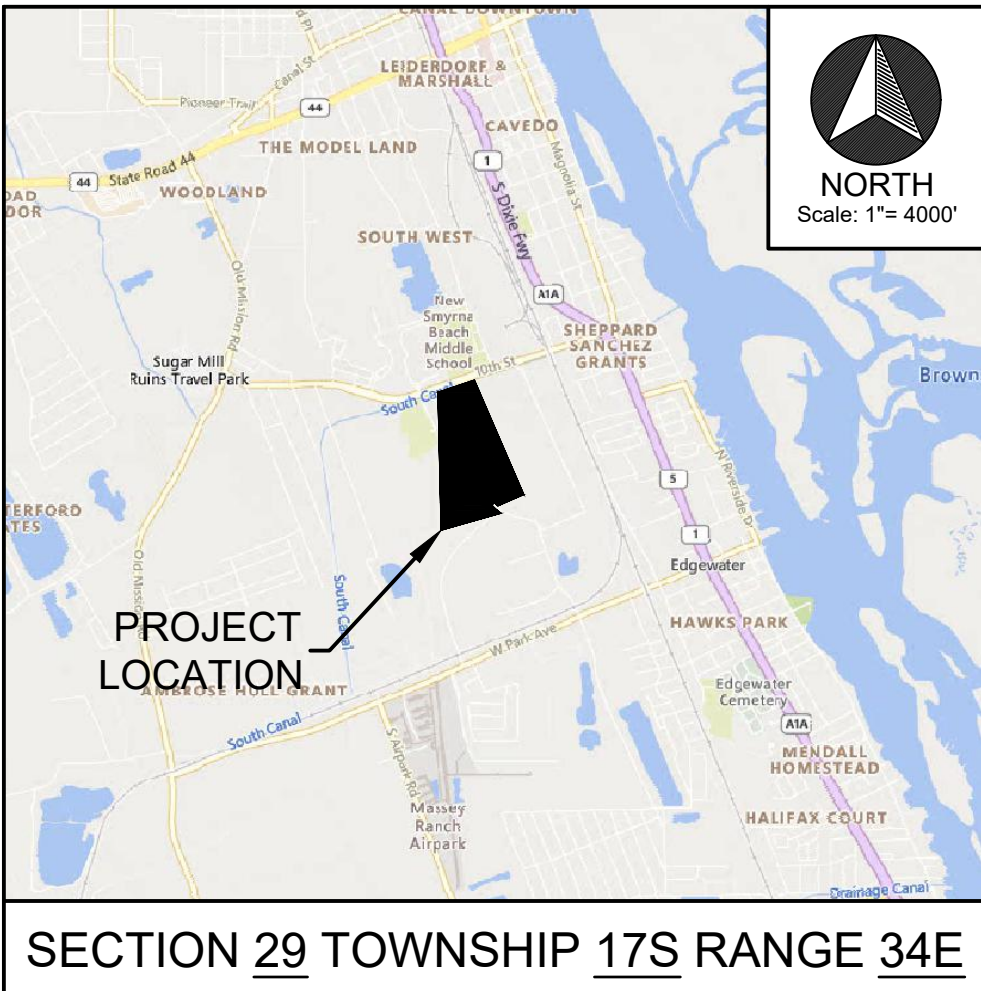

LOCATION MAP

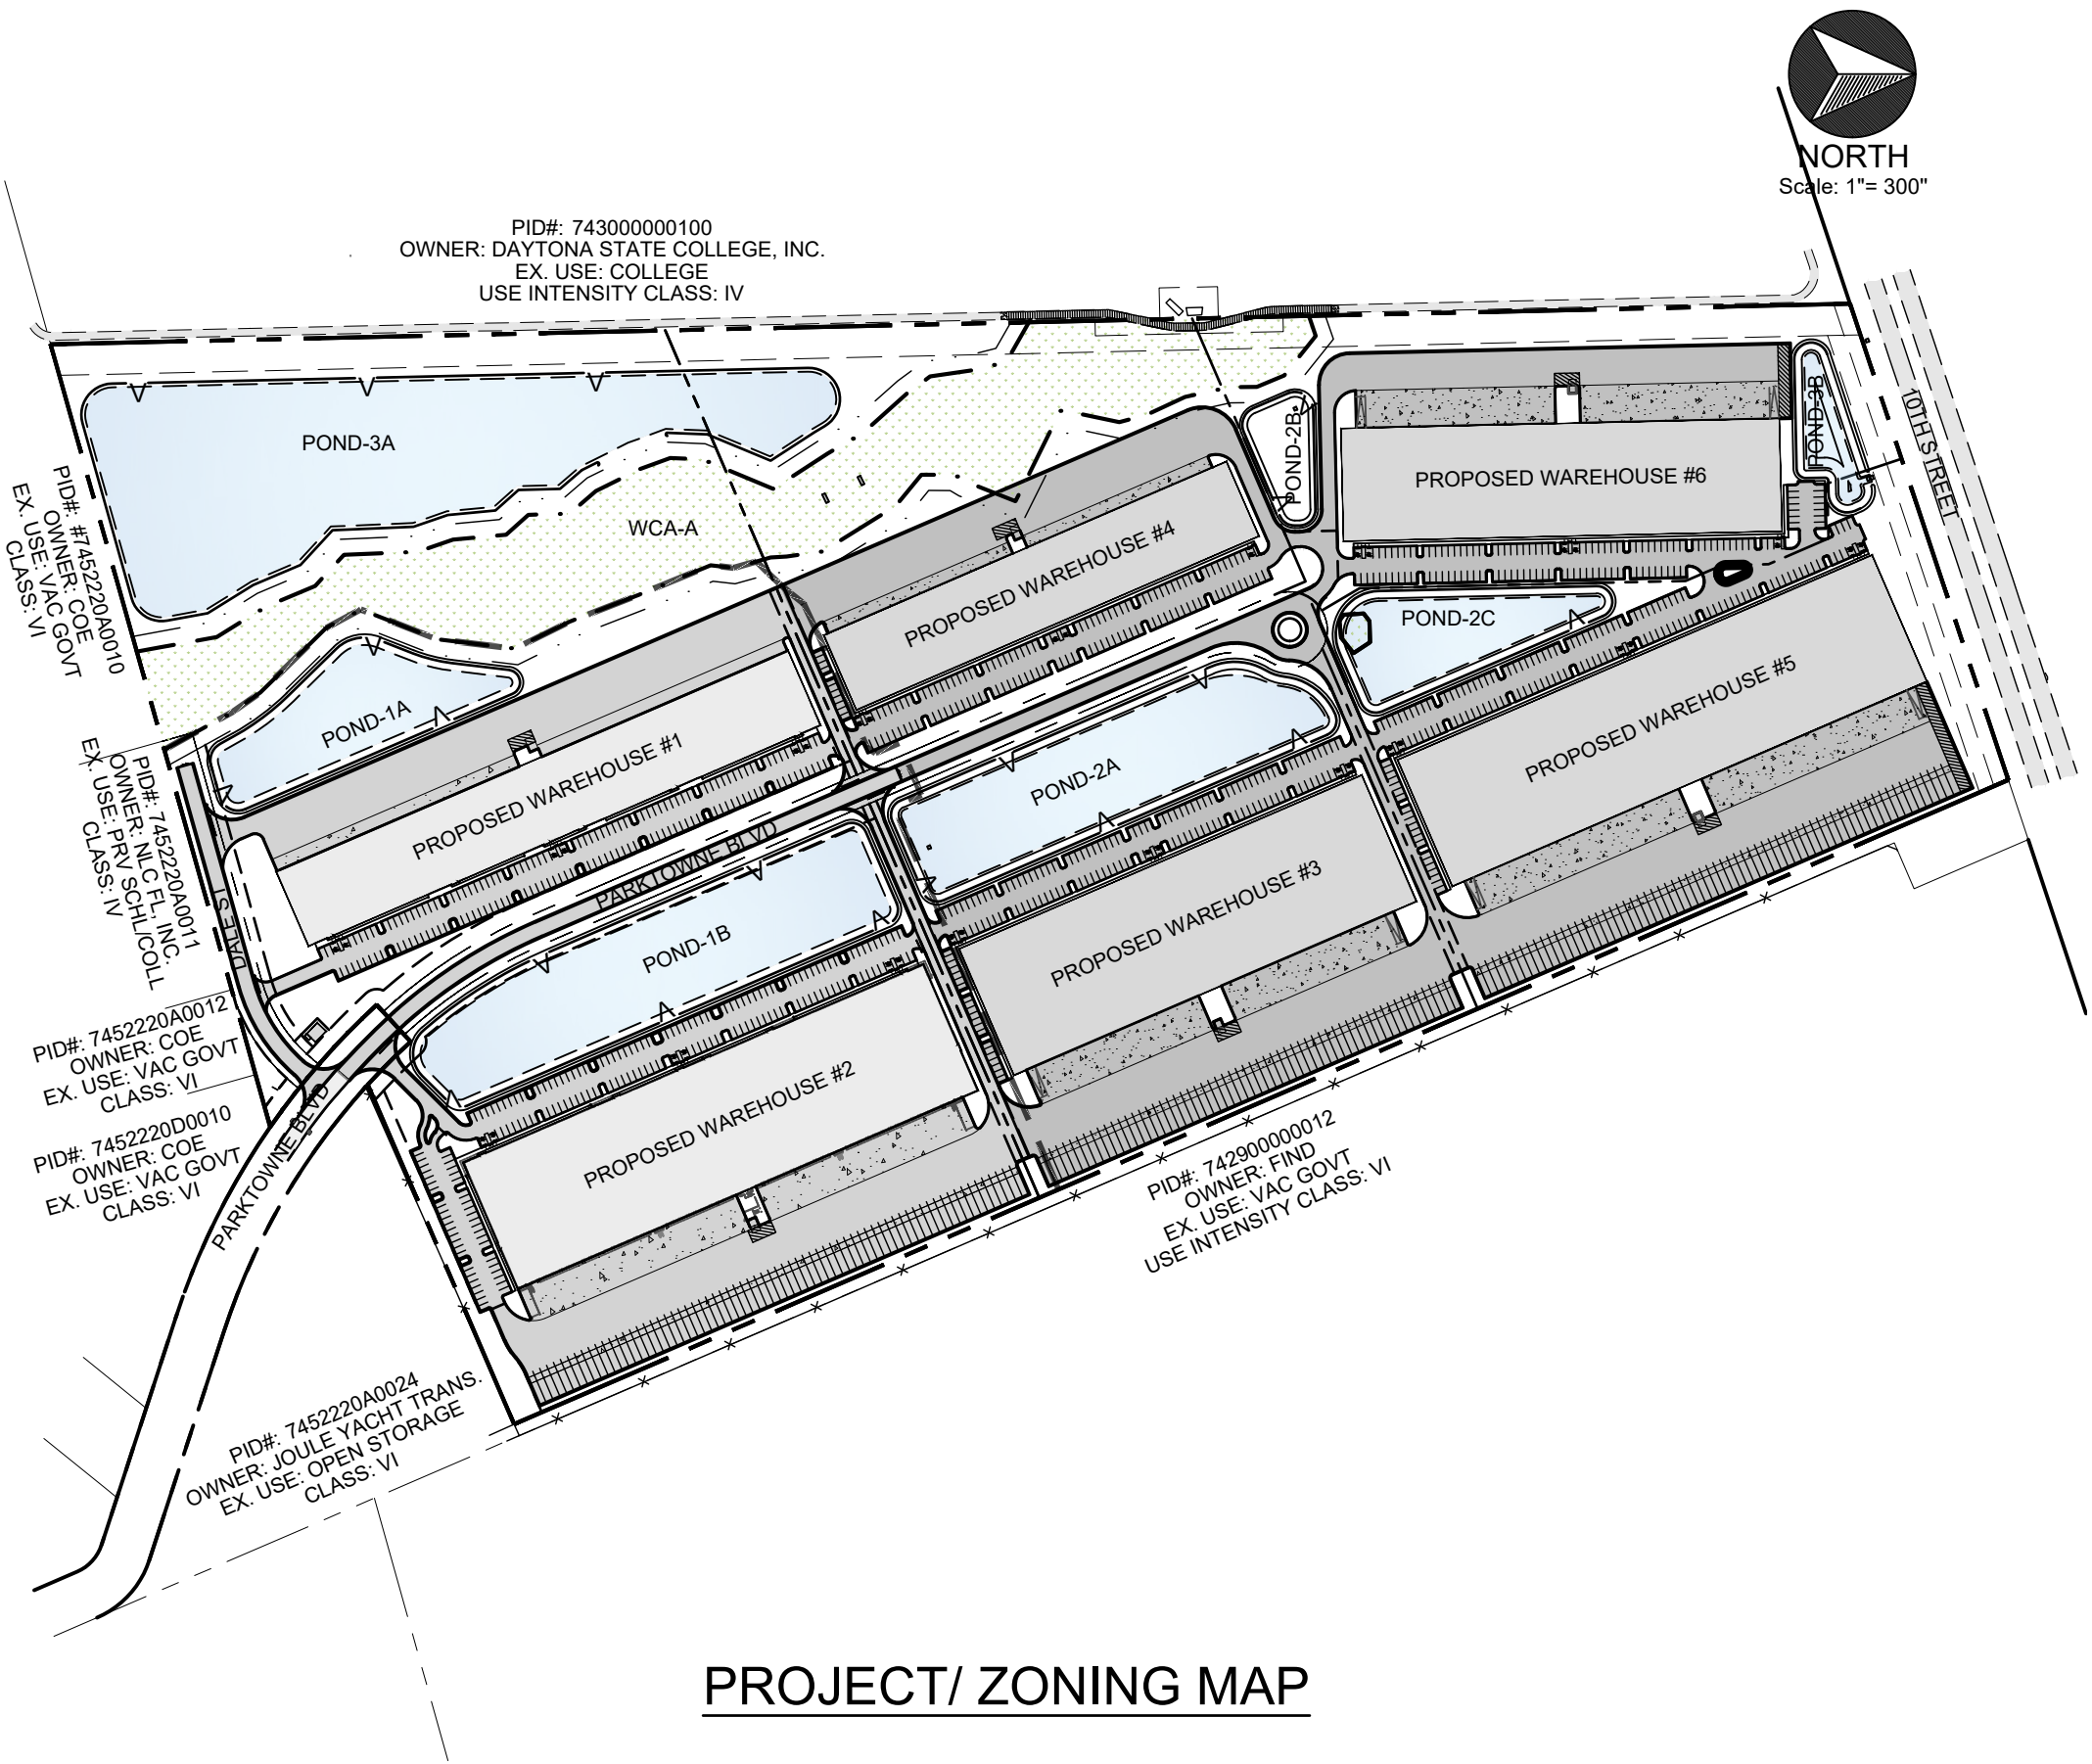

CIVIL ENGINEER:



4206 NATIONAL GUARD DRIVE, #1  
PLANT CITY, FL 33563  
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FL Registry 36174 FL L22000260419

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ASSOCIATED LAND SURVEYING  
& MAPPING, INC.  
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LONGWOOD, FLORIDA 32750  
Phone (407) 869-5002 Email ALSM@ALSM.NET  
CERTIFICATE OF AUTHORIZATION No 6787


LANDSCAPE ARCHITECT:

STURCH DESIGN GROUP  
11411 CYPRESS PARK ST.  
TAMPA, FL 33624  
Phone (813) 610-4525 Email sturchdesign@gmail.com  
FL LA 00001295

INDEX OF DRAWINGS


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|------|--|
| C-01 | COVER SHEET                            |
| C-02 | MASTER DEV. STATISTICAL TREE SURVEY    |
| C-03 | MASTER DEVELOPMENT LIT MANAGEMENT PLAN |
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Project Name  
SPACE COAST COMMERCE PARK  
@ PARKTOWNE  
CITY OF EDGEWATER, FL  
Prepared For  
ONICX MANAGEMENT GROUP, LLC

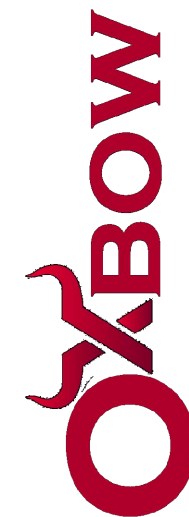

4206 NATIONAL GUARD DRIVE, #1  
PLANT CITY, FL 33563  
Phone (813) 857-7024 Web www.oxboweng.com  
FL Registry 36174 FL L22000260419

| Revision No. | Date       | Description                  |
|--------------|------------|------------------------------|
| 1            | 2023-08-08 | Preliminary Plat Resubmittal |
|              |            |                              |
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This item has been digitally signed and sealed by Michael J. Sanders, Jr., P.E. on the date adjacent to the seal.  
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Project No.: 1001-002  
Issued: AUG 21, 2023  
Drawn By: ECC  
Checked By: MJS  
Scale: 1" = 300'

Sheet Title  
COVER SHEET

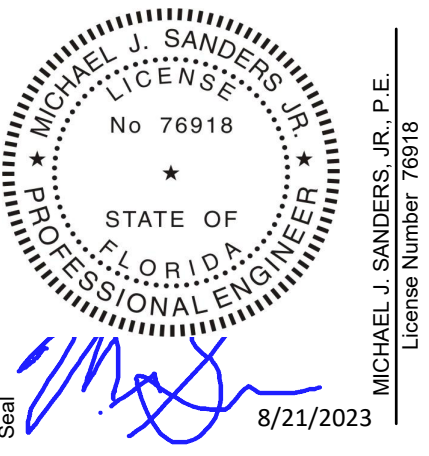Sheet Number  
C-01



STATISTICAL TREE SURVEY NOTES

1. A STATISTICAL TREE SURVEY WAS PREPARED IN ACCORDANCE WITH CITY OF EDGEWATER LOC. (21-55.07)(C.) THE SURVEY COMPLIES WITH ACCEPTABLE FORESTRY PRACTICES UTILIZING "1-TREE ECOT" PLOT METHODOLOGY DEVELOPED IN CONJUNCTION WITH THE USDA FORESTRY SERVICE SUPPORTED BY THE FLORIDA URBAN FORESTRY COUNCIL.
2. THE SUBJECT SITE OF APPROXIMATELY 83.35 ACRES IS HOMOGENOUS IN TREE CANOPY COVERAGE THEREFORE (10) RANDOM 0.1 ACRES CIRCULAR PLOTS WITH RADIUS OF 37.2 FEET WITHIN THE PROJECT SITE WERE SURVEYED TO ESTIMATE TREE INVENTORY FOR THE MASTER DEVELOPMENT.
3. PROVIDED PLOT DATA IS BASED UPON THE SPECIFIC PURPOSE TREE SURVEY PREPARED BY ALSM DATED (2/25/23).

| STASTICAL TREE SURVEY DATA - PLOT 1 |       |             |                |          |                 |
|-------------------------------------|-------|-------------|----------------|----------|-----------------|
| Plot                                | ID    | Common Name | Botanical Name | DBH (in) | COE Designation |
| 1                                   | 10270 | Palm        | Arecaceae      | 12       | Non-Mitigated   |
| 1                                   | 10271 | Palm        | Arecaceae      | 11       | Non-Mitigated   |
| 1                                   | 10272 | Palm        | Arecaceae      | 10       | Non-Mitigated   |
| 1                                   | 10273 | Palm        | Arecaceae      | 13       | Non-Mitigated   |
| 1                                   | 10274 | Palm        | Arecaceae      | 13       | Non-Mitigated   |
| 1                                   | 10275 | Palm        | Arecaceae      | 13       | Non-Mitigated   |
| 1                                   | 10276 | Oak         | Quercus Spp.   | 36       | Historic        |
| 1                                   | 10277 | Oak         | Quercus Spp.   | 14       | Specimen        |
| 1                                   | 10278 | Palm        | Arecaceae      | 14       | Non-Mitigated   |
| 1                                   | 10279 | Palm        | Arecaceae      | 15       | Non-Mitigated   |
| 1                                   | 10280 | Palm        | Arecaceae      | 11       | Non-Mitigated   |
| 1                                   | 10281 | Palm        | Arecaceae      | 12       | Non-Mitigated   |
| 1                                   | 10282 | Palm        | Arecaceae      | 12       | Non-Mitigated   |
| 1                                   | 10283 | Oak         | Quercus Spp.   | 17       | Specimen        |
| 1                                   | 10284 | Palm        | Arecaceae      | 9        | Non-Mitigated   |
| 1                                   | 10285 | Palm        | Arecaceae      | 13       | Non-Mitigated   |
| 1                                   | 10286 | Palm        | Arecaceae      | 10       | Non-Mitigated   |
| 1                                   | 10287 | Palm        | Arecaceae      | 12       | Non-Mitigated   |
| 1                                   | 10288 | Palm        | Arecaceae      | 9        | Non-Mitigated   |
| 1                                   | 10289 | Palm        | Arecaceae      | 8        | Non-Mitigated   |
| 1                                   | 10290 | Palm        | Arecaceae      | 13       | Non-Mitigated   |
| 1                                   | 10291 | Palm        | Arecaceae      | 11       | Non-Mitigated   |
| 1                                   | 10292 | Oak         | Quercus Spp.   | 12       | Specimen        |
| 1                                   | 10293 | Oak         | Quercus Spp.   | 14       | Specimen        |
| 1                                   | 10294 | Palm        | Arecaceae      | 10       | Non-Mitigated   |
| 1                                   | 10295 | Oak         | Quercus Spp.   | 23       | Specimen        |
| 1                                   | 10296 | Palm        | Arecaceae      | 10       | Non-Mitigated   |
| 1                                   | 10297 | Palm        | Arecaceae      | 9        | Non-Mitigated   |
| 1                                   | 10298 | Palm        | Arecaceae      | 12       | Non-Mitigated   |
| 1                                   | 10299 | Palm        | Arecaceae      | 12       | Non-Mitigated   |
| 1                                   | 10300 | Palm        | Arecaceae      | 9        | Non-Mitigated   |
| 1                                   | 10301 | Palm        | Arecaceae      | 14       | Non-Mitigated   |
| 1                                   | 10302 | Palm        | Arecaceae      | 12       | Non-Mitigated   |
| 1                                   | 10303 | Palm        | Arecaceae      | 13       | Non-Mitigated   |
| 1                                   | 10304 | Oak         | Quercus Spp.   | 17       | Specimen        |

| STASTICAL TREE SURVEY DATA - PLOT 2 |      |               |                    |          |                 |
|-------------------------------------|------|---------------|--------------------|----------|-----------------|
| Plot                                | ID   | Common Name   | Botanical Name     | DBH (in) | COE Designation |
| 2                                   | 1576 | Oak           | Quercus Spp.       | 41       | Historic        |
| 2                                   | 1577 | Cherry Laural | Prunus Caroliniana | 7        | Non-Mitigated   |
| 2                                   | 1578 | Oak           | Quercus Spp.       | 19       | Specimen        |
| 2                                   | 1579 | Palm          | Arecaceae          | 13       | Non-Mitigated   |
| 2                                   | 1580 | Oak           | Quercus Spp.       | 20       | Specimen        |
| 2                                   | 1581 | Palm          | Arecaceae          | 9        | Non-Mitigated   |
| 2                                   | 1582 | Oak           | Quercus Spp.       | 28       | Specimen        |
| 2                                   | 1583 | Palm          | Arecaceae          | 12       | Non-Mitigated   |
| 2                                   | 1584 | Palm          | Arecaceae          | 14       | Non-Mitigated   |

| STASTICAL TREE SURVEY DATA - PLOT 3 |      |             |                |          |                 |
|-------------------------------------|------|-------------|----------------|----------|-----------------|
| Plot                                | ID   | Common Name | Botanical Name | DBH (in) | COE Designation |
| 3                                   | 1640 | Oak         | Quercus Spp.   | 15       | Specimen        |
| 3                                   | 1641 | Oak         | Quercus Spp.   | 12       | Specimen        |
| 3                                   | 1642 | Oak         | Quercus Spp.   | 10       | Non-Mitigated   |
| 3                                   | 1643 | Oak         | Quercus Spp.   | 19       | Specimen        |
| 3                                   | 1644 | Oak         | Quercus Spp.   | 12       | Specimen        |
| 3                                   | 1645 | Oak         | Quercus Spp.   | 12       | Specimen        |
| 3                                   | 1646 | Oak         | Quercus Spp.   | 13       | Specimen        |
| 3                                   | 1647 | Oak         | Quercus Spp.   | 11       | Non-Mitigated   |
| 3                                   | 1648 | Oak         | Quercus Spp.   | 7        | Non-Mitigated   |
| 3                                   | 1649 | Oak         | Quercus Spp.   | 7        | Non-Mitigated   |
| 3                                   | 1650 | Oak         | Quercus Spp.   | 6        | Non-Mitigated   |
| 3                                   | 1651 | Oak         | Quercus Spp.   | 9        | Non-Mitigated   |
| 3                                   | 1652 | Oak         | Quercus Spp.   | 18       | Specimen        |
| 3                                   | 1653 | Oak         | Quercus Spp.   | 9        | Non-Mitigated   |
| 3                                   | 1654 | Oak         | Quercus Spp.   | 8        | Non-Mitigated   |
| 3                                   | 1655 | Oak         | Quercus Spp.   | 6        | Non-Mitigated   |
| 3                                   | 1656 | Oak         | Quercus Spp.   | 7        | Non-Mitigated   |
| 3                                   | 1657 | Oak         | Quercus Spp.   | 6        | Non-Mitigated   |
| 3                                   | 1658 | Oak         | Quercus Spp.   | 9        | Non-Mitigated   |
| 3                                   | 1659 | Oak         | Quercus Spp.   | 7        | Non-Mitigated   |
| 3                                   | 1660 | Oak         | Quercus Spp.   | 9        | Non-Mitigated   |
| 3                                   | 1661 | Oak         | Quercus Spp.   | 9        | Non-Mitigated   |
| 3                                   | 1662 | Pine        | Pinus          | 14       | Non-Mitigated   |

| STASTICAL TREE SURVEY DATA - PLOT 4 |      |             |                |          |                 |
|-------------------------------------|------|-------------|----------------|----------|-----------------|
| Plot                                | ID   | Common Name | Botanical Name | DBH (in) | COE Designation |
| 4                                   | 1586 | Palm        | Arecaceae      | 8        | Non-Mitigated   |
| 4                                   | 1587 | Palm        | Arecaceae      | 8        | Non-Mitigated   |
| 4                                   | 1588 | Palm        | Arecaceae      | 12       | Non-Mitigated   |
| 4                                   | 1589 | Palm        | Arecaceae      | 10       | Non-Mitigated   |
| 4                                   | 1590 | Palm        | Arecaceae      | 13       | Non-Mitigated   |
| 4                                   | 1591 | Palm        | Arecaceae      | 10       | Non-Mitigated   |
| 4                                   | 1592 | Palm        | Arecaceae      | 14       | Non-Mitigated   |
| 4                                   | 1593 | Cherry      | Prunus         | 10       | Non-Mitigated   |
| 4                                   | 1594 | Cherry      | Prunus         | 9        | Non-Mitigated   |
| 4                                   | 1595 | Oak         | Quercus Spp.   | 29       | Specimen        |
| 4                                   | 1596 | Oak         | Quercus Spp.   | 24       | Specimen        |
| 4                                   | 1597 | Palm        | Arecaceae      | 10       | Non-Mitigated   |
| 4                                   | 1598 | Palm        | Arecaceae      | 10       | Non-Mitigated   |
| 4                                   | 1599 | Palm        | Arecaceae      | 10       | Non-Mitigated   |
| 4                                   | 1600 | Oak         | Quercus Spp.   | 7        | Non-Mitigated   |
| 4                                   | 1601 | Oak         | Quercus Spp.   | 18       | Specimen        |
| 4                                   | 1602 | Oak         | Quercus Spp.   | 15       | Specimen        |
| 4                                   | 1603 | Palm        | Arecaceae      | 12       | Non-Mitigated   |
| 4                                   | 1604 | Palm        | Arecaceae      | 9        | Non-Mitigated   |
| 4                                   | 1605 | Palm        | Arecaceae      | 11       | Non-Mitigated   |
| 4                                   | 1606 | Palm        | Arecaceae      | 11       | Non-Mitigated   |
| 4                                   | 1607 | Palm        | Arecaceae      | 8        | Non-Mitigated   |
| 4                                   | 1608 | Palm        | Arecaceae      | 11       | Non-Mitigated   |
| 4                                   | 1609 | Palm        | Arecaceae      | 10       | Non-Mitigated   |
| 4                                   | 1610 | Oak         | Quercus Spp.   | 12       | Specimen        |
| 4                                   | 1611 | Oak         | Quercus Spp.   | 10       | Non-Mitigated   |
| 4                                   | 1612 | Palm        | Arecaceae      | 9        | Non-Mitigated   |
| 4                                   | 1613 | Oak         | Quercus Spp.   | 17       | Specimen        |
| 4                                   | 1614 | Palm        | Arecaceae      | 9        | Non-Mitigated   |
| 4                                   | 1615 | Oak         | Quercus Spp.   | 12       | Specimen        |
| 4                                   | 1616 | Palm        | Arecaceae      | 9        | Non-Mitigated   |
| 4                                   | 1617 | Palm        | Arecaceae      | 12       | Non-Mitigated   |
| 4                                   | 1618 | Palm        | Arecaceae      | 9        | Non-Mitigated   |
| 4                                   | 1619 | Palm        | Arecaceae      | 9        | Non-Mitigated   |
| 4                                   | 1620 | Palm        | Arecaceae      | 12       | Non-Mitigated   |
| 4                                   | 1621 | Palm        | Arecaceae      | 6        | Non-Mitigated   |
| 4                                   | 1622 | Palm        | Arecaceae      | 8        | Non-Mitigated   |
| 4                                   | 1623 | Oak         | Quercus Spp.   | 20       | Specimen        |
| 4                                   | 1624 | Palm        | Arecaceae      | 9        | Non-Mitigated   |
| 4                                   | 1625 | Palm        | Arecaceae      | 10       | Non-Mitigated   |
| 4                                   | 1626 | Palm        | Arecaceae      | 9        | Non-Mitigated   |
| 4                                   | 1627 | Palm        | Arecaceae      | 8        | Non-Mitigated   |
| 4                                   | 1628 | Palm        | Arecaceae      | 8        | Non-Mitigated   |
| 4                                   | 1629 | Palm        | Arecaceae      | 12       | Non-Mitigated   |
| 4                                   | 1630 | Palm        | Arecaceae      | 12       | Non-Mitigated   |
| 4                                   | 1631 | Palm        | Arecaceae      | 12       | Non-Mitigated   |
| 4                                   | 1632 | Cherry      | Prunus         | 6        | Non-Mitigated   |

| STASTICAL TREE SURVEY DATA - PLOT 5 |      |             |                |          |                 |
|-------------------------------------|------|-------------|----------------|----------|-----------------|
| Plot                                | ID   | Common Name | Botanical Name | DBH (in) | COE Designation |
| 5                                   | 1698 | Oak         | Quercus Spp.   | 9        | Non-Mitigated   |
| 5                                   | 1699 | Oak         | Quercus Spp.   | 7        | Non-Mitigated   |
| 5                                   | 1700 | Oak         | Quercus Spp.   | 9        | Non-Mitigated   |
| 5                                   | 1701 | Palm        | Arecaceae      | 11       | Non-Mitigated   |
| 5                                   | 1702 | Palm        | Arecaceae      | 12       | Non-Mitigated   |
| 5                                   | 1703 | Palm        | Arecaceae      | 14       | Non-Mitigated   |
| 5                                   | 1704 | Palm        | Arecaceae      | 11       | Non-Mitigated   |
| 5                                   | 1705 | Palm        | Arecaceae      | 12       | Non-Mitigated   |
| 5                                   | 1706 | Pine        | Pinus          | 12       | Non-Mitigated   |
| 5                                   | 1707 | Palm        | Arecaceae      | 10       | Non-Mitigated   |
| 5                                   | 1708 | Palm        | Arecaceae      | 12       | Non-Mitigated   |
| 5                                   | 1709 | Palm        | Arecaceae      | 8        | Non-Mitigated   |
| 5                                   | 1710 | Palm        | Arecaceae      | 9        | Non-Mitigated   |
| 5                                   | 1711 | Palm        | Arecaceae      | 9        | Non-Mitigated   |
| 5                                   | 1712 | Oak         | Quercus Spp.   | 24       | Specimen        |
| 5                                   | 1713 | Oak         | Quercus Spp.   | 13       | Specimen        |
| 5                                   | 1714 | Oak         | Quercus Spp.   | 16       | Specimen        |
| 5                                   | 1715 | Oak         | Quercus Spp.   | 21       | Specimen        |
| 5                                   | 1716 | Oak         | Quercus Spp.   | 10       | Non-Mitigated   |


| STASTICAL TREE SURVEY DATA - PLOT 6 |      |             |                |          |                 |
|-------------------------------------|------|-------------|----------------|----------|-----------------|
| Plot                                | ID   | Common Name | Botanical Name | DBH (in) | COE Designation |
| 6                                   | 1664 | Oak         | Quercus Spp.   | 18       | Specimen        |
| 6                                   | 1665 | Oak         | Quercus Spp.   | 9        | Non-Mitigated   |
| 6                                   | 1666 | Oak         | Quercus Spp.   | 6        | Non-Mitigated   |
| 6                                   | 1667 | Oak         | Quercus Spp.   | 9        | Non-Mitigated   |
| 6                                   | 1668 | Oak         | Quercus Spp.   | 12       | Specimen        |
| 6                                   | 1669 | Oak         | Quercus Spp.   | 6        | Non-Mitigated   |
| 6                                   | 1670 | Oak         | Quercus Spp.   | 6        | Non-Mitigated   |
| 6                                   | 1671 | Oak         | Quercus Spp.   | 10       | Non-Mitigated   |
| 6                                   | 1672 | Oak         | Quercus Spp.   | 11       | Non-Mitigated   |
| 6                                   | 1673 | Oak         | Quercus Spp.   | 6        | Non-Mitigated   |
| 6                                   | 1674 | Palm        | Arecaceae      | 9        | Non-Mitigated   |
| 6                                   | 1675 | Palm        | Arecaceae      | 11       | Non-Mitigated   |
| 6                                   | 1676 | Palm        | Arecaceae      | 12       | Non-Mitigated   |
| 6                                   | 1677 | Palm        | Arecaceae      | 10       | Non-Mitigated   |
| 6                                   | 1678 | Palm        | Arecaceae      | 12       | Non-Mitigated   |
| 6                                   | 1679 | Palm        | Arecaceae      | 8        | Non-Mitigated   |
| 6                                   | 1680 | Palm        | Arecaceae      | 11       | Non-Mitigated   |
| 6                                   | 1681 | Palm        | Arecaceae      | 9        | Non-Mitigated   |
| 6                                   | 1682 | Palm        | Arecaceae      | 11       | Non-Mitigated   |
| 6                                   | 1683 | Palm        | Arecaceae      | 11       | Non-Mitigated   |
| 6                                   | 1684 | Palm        | Arecaceae      | 8        | Non-Mitigated   |
| 6                                   | 1685 | Oak         | Quercus Spp.   | 7        | Non-Mitigated   |
| 6                                   | 1686 | Oak         | Quercus Spp.   | 9        | Non-Mitigated   |
| 6                                   | 1687 | Oak         | Quercus Spp.   | 8        | Non-Mitigated   |
| 6                                   | 1688 | Oak         | Quercus Spp.   | 6        | Non-Mitigated   |
| 6                                   | 1689 | Oak         | Quercus Spp.   | 12       | Specimen        |
| 6                                   | 1690 | Oak         | Quercus Spp.   | 8        | Non-Mitigated   |
| 6                                   | 1691 | Oak         | Quercus Spp.   | 6        | Non-Mitigated   |
| 6                                   | 1692 | Oak         | Quercus Spp.   | 6        | Non-Mitigated   |
| 6                                   | 1693 | Oak         | Quercus Spp.   | 8        | Non-Mitigated   |
| 6                                   | 1694 | Oak         | Quercus Spp.   | 10       | Non-Mitigated   |
| 6                                   | 1695 | Oak         | Quercus Spp.   | 7        | Non-Mitigated   |
| 6                                   | 1696 | Oak         | Quercus Spp.   | 15       | Specimen        |

| STASTICAL TREE SURVEY DATA - PLOT 7 |      |             |                |          |                 |
|-------------------------------------|------|-------------|----------------|----------|-----------------|
| Plot                                | ID   | Common Name | Botanical Name | DBH (in) | COE Designation |
| 7                                   | 1291 | Pine        | Pinus          | 15       | Non-Mitigated   |
| 7                                   | 1292 | Pine        | Pinus          | 10       | Non-Mitigated   |
| 7                                   | 1293 | Palm        | Arecaceae      | 9        | Non-Mitigated   |
| 7                                   | 1294 | Oak         | Quercus Spp.   | 6        | Non-Mitigated   |
| 7                                   | 1295 | Oak         | Quercus Spp.   | 11       | Non-Mitigated   |
| 7                                   | 1296 | Palm        | Arecaceae      | 9        | Non-Mitigated   |
| 7                                   | 1297 | Palm        | Arecaceae      | 9        | Non-Mitigated   |
| 7                                   | 1298 | Palm        | Arecaceae      | 11       | Non-Mitigated   |
| 7                                   | 1299 | Palm        | Arecaceae      | 9        | Non-Mitigated   |
| 7                                   | 1300 | Palm        | Arecaceae      | 12       | Non-Mitigated   |
| 7                                   | 1301 | Palm        | Arecaceae      | 12       | Non-Mitigated   |
| 7                                   | 1302 | Oak         | Quercus Spp.   | 8        | Non-Mitigated   |
| 7                                   | 1303 | Palm        | Arecaceae      | 8        | Non-Mitigated   |
| 7                                   | 1304 | Palm        | Arecaceae      | 10       | Non-Mitigated   |
| 7                                   | 1305 | Palm        | Arecaceae      | 11       | Non-Mitigated   |
| 7                                   | 1306 | Oak         | Quercus Spp.   | 6        | Non-Mitigated   |
| 7                                   | 1307 | Palm        | Arecaceae      | 12       | Non-Mitigated   |
| 7                                   | 1308 | Oak         | Quercus Spp.   | 9        | Non-Mitigated   |
| 7                                   | 1309 | Palm        | Arecaceae      | 10       | Non-Mitigated   |
| 7                                   | 1310 | Palm        | Arecaceae      | 10       | Non-Mitigated   |
| 7                                   | 1311 | Palm        | Arecaceae      | 8        | Non-Mitigated   |
| 7                                   | 1312 | Palm        | Arecaceae      | 11       | Non-Mitigated   |
| 7                                   | 1313 | Oak         | Quercus Spp.   | 26       | Specimen        |
| 7                                   | 1314 | Oak         | Quercus Spp.   | 10       | Non-Mitigated   |
| 7                                   | 1315 | Palm        | Arecaceae      | 10       | Non-Mitigated   |
| 7                                   | 1316 | Palm        | Arecaceae      | 9        | Non-Mitigated   |
| 7                                   | 1317 | Palm        | Arecaceae      | 8        | Non-Mitigated   |
| 7                                   | 1318 | Palm        | Arecaceae      | 8        | Non-Mitigated   |
| 7                                   | 1319 | Oak         | Quercus Spp.   | 6        | Non-Mitigated   |
| 7                                   | 1320 | Oak         | Quercus Spp.   | 7        | Non-Mitigated   |
| 7                                   | 1321 | Oak         | Quercus Spp.   | 13       | Specimen        |


| STASTICAL TREE SURVEY DATA - PLOT 8 |      |             |                |          |                 |
|-------------------------------------|------|-------------|----------------|----------|-----------------|
| Plot                                | ID   | Common Name | Botanical Name | DBH (in) | COE Designation |
| 8                                   | 1223 | Oak         | Quercus Spp.   | 6        | Non-Mitigated   |
| 8                                   | 1224 | Oak         | Quercus Spp.   | 6        | Non-Mitigated   |
| 8                                   | 1225 | Oak         | Quercus Spp.   | 10       | Non-Mitigated   |
| 8                                   | 1226 | Oak         | Quercus Spp.   | 12       | Specimen        |
| 8                                   | 1227 | Oak         | Quercus Spp.   | 7        | Non-Mitigated   |
| 8                                   | 1228 | Oak         | Quercus Spp.   | 7        | Non-Mitigated   |
| 8                                   | 1229 | Oak         | Quercus Spp.   | 6        | Non-Mitigated   |
| 8                                   | 1230 | Oak         | Quercus Spp.   | 7        | Non-Mitigated   |
| 8                                   | 1231 | Oak         | Quercus Spp.   | 6        | Non-Mitigated   |
| 8                                   | 1232 | Oak         | Quercus Spp.   | 6        | Non-Mitigated   |
| 8                                   | 1233 | Oak         | Quercus Spp.   | 6        | Non-Mitigated   |
| 8                                   | 1234 | Oak         | Quercus Spp.   | 7        | Non-Mitigated   |
| 8                                   | 1235 | Oak         | Quercus Spp.   | 6        | Non-Mitigated   |
| 8                                   | 1236 | Oak         | Quercus Spp.   | 7        | Non-Mitigated   |

| STASTICAL TREE SURVEY DATA - PLOT 9 |      |             |                |          |                 |
|-------------------------------------|------|-------------|----------------|----------|-----------------|
| Plot                                | ID   | Common Name | Botanical Name | DBH (in) | COE Designation |
| 9                                   | 1239 | Oak         | Quercus Spp.   | 16       | Specimen        |
| 9                                   | 1240 | Pine        | Pinus          | 12       | Non-Mitigated   |
| 9                                   | 1241 | Pine        | Pinus          | 12       | Non-Mitigated   |
| 9                                   | 1242 | Palm        | Arecaceae      | 10       | Non-Mitigated   |
| 9                                   | 1243 | Palm        | Arecaceae      | 13       | Non-Mitigated   |
| 9                                   | 1244 | Palm        | Arecaceae      | 14       | Non-Mitigated   |
| 9                                   | 1245 | Palm        | Arecaceae      | 9        | Non-Mitigated   |
| 9                                   | 1246 | Palm        | Arecaceae      | 10       | Non-Mitigated   |
| 9                                   | 1247 | Palm        | Arecaceae      | 13       | Non-Mitigated   |
| 9                                   | 1248 | Palm        | Arecaceae      | 10       | Non-Mitigated   |
| 9                                   | 1249 | Palm        | Arecaceae      | 10       | Non-Mitigated   |
| 9                                   | 1250 | Pine        | Pinus          | 10       | Non-Mitigated   |
| 9                                   | 1251 | Oak         | Quercus Spp.   | 8        | Non-Mitigated   |
| 9                                   | 1252 | Oak         | Quercus Spp.   | 7        | Non-Mitigated   |
| 9                                   | 1253 | Oak         | Quercus Spp.   | 13       | Specimen        |
| 9                                   | 1254 | Palm        | Arecaceae      | 11       | Non-Mitigated   |
| 9                                   | 1255 | Oak         | Quercus Spp.   | 7        | Non-Mitigated   |
| 9                                   | 1256 | Palm        | Arecaceae      | 11       | Non-Mitigated   |
| 9                                   | 1257 | Oak         | Quercus Spp.   | 20       | Specimen        |
| 9                                   | 1258 | Palm        | Arecaceae      | 10       | Non-Mitigated   |
| 9                                   | 1259 | Oak         | Quercus Spp.   | 6        | Non-Mitigated   |
| 9                                   | 1260 | Palm        | Arecaceae      | 10       | Non-Mitigated   |
| 9                                   | 1261 | Palm        | Arecaceae      | 8        | Non-Mitigated   |
| 9                                   | 1262 | Palm        | Arecaceae      | 12       | Non-Mitigated   |
| 9                                   | 1263 | Palm        | Arecaceae      | 11       | Non-Mitigated   |
| 9                                   | 1264 | Palm        | Arecaceae      | 12       | Non-Mitigated   |
| 9                                   | 1265 | Oak         | Quercus Spp.   | 9        | Non-Mitigated   |
| 9                                   | 1266 | Palm        | Arecaceae      | 8        | Non-Mitigated   |
| 9                                   | 1267 | Pine        | Pinus          | 10       | Non-Mitigated   |
| 9                                   | 1268 | Palm        | Arecaceae      | 9        | Non-Mitigated   |
| 9                                   | 1269 | Pine        | Pinus          | 12       | Non-Mitigated   |
| 9                                   | 1270 | Palm        | Arecaceae      | 10       | Non-Mitigated   |
| 9                                   | 1271 | Oak         | Quercus Spp.   | 9        | Non-Mitigated   |
| 9                                   | 1272 | Palm        | Arecaceae      | 8        | Non-Mitigated   |
| 9                                   | 1273 | Palm        | Arecaceae      | 8        | Non-Mitigated   |
| 9                                   | 1274 | Palm        | Arecaceae      | 11       | Non-Mitigated   |
| 9                                   | 1275 | Oak         | Quercus Spp.   | 11       | Non-Mitigated   |
| 9                                   | 1276 | Palm        | Arecaceae      | 10       | Non-Mitigated   |
| 9                                   | 1277 | Palm        | Arecaceae      | 13       | Non-Mitigated   |
| 9                                   | 1278 | Palm        | Arecaceae      | 10       | Non-Mitigated   |
| 9                                   | 1279 | Palm        | Arecaceae      | 10       | Non-Mitigated   |
| 9                                   | 1280 | Palm        | Arecaceae      | 11       | Non-Mitigated   |
| 9                                   | 1281 | Palm        | Arecaceae      | 11       | Non-Mitigated   |
| 9                                   | 1282 | Palm        | Arecaceae      | 11       | Non-Mitigated   |
| 9                                   | 1283 | Palm        | Arecaceae      | 8        | Non-Mitigated   |
| 9                                   | 1284 | Palm        | Arecaceae      | 11       | Non-Mitigated   |
| 9                                   | 1285 | Palm        | Arecaceae      | 9        | Non-Mitigated   |
| 9                                   | 1288 | Palm        | Arecaceae      | 10       | Non-Mitigated   |



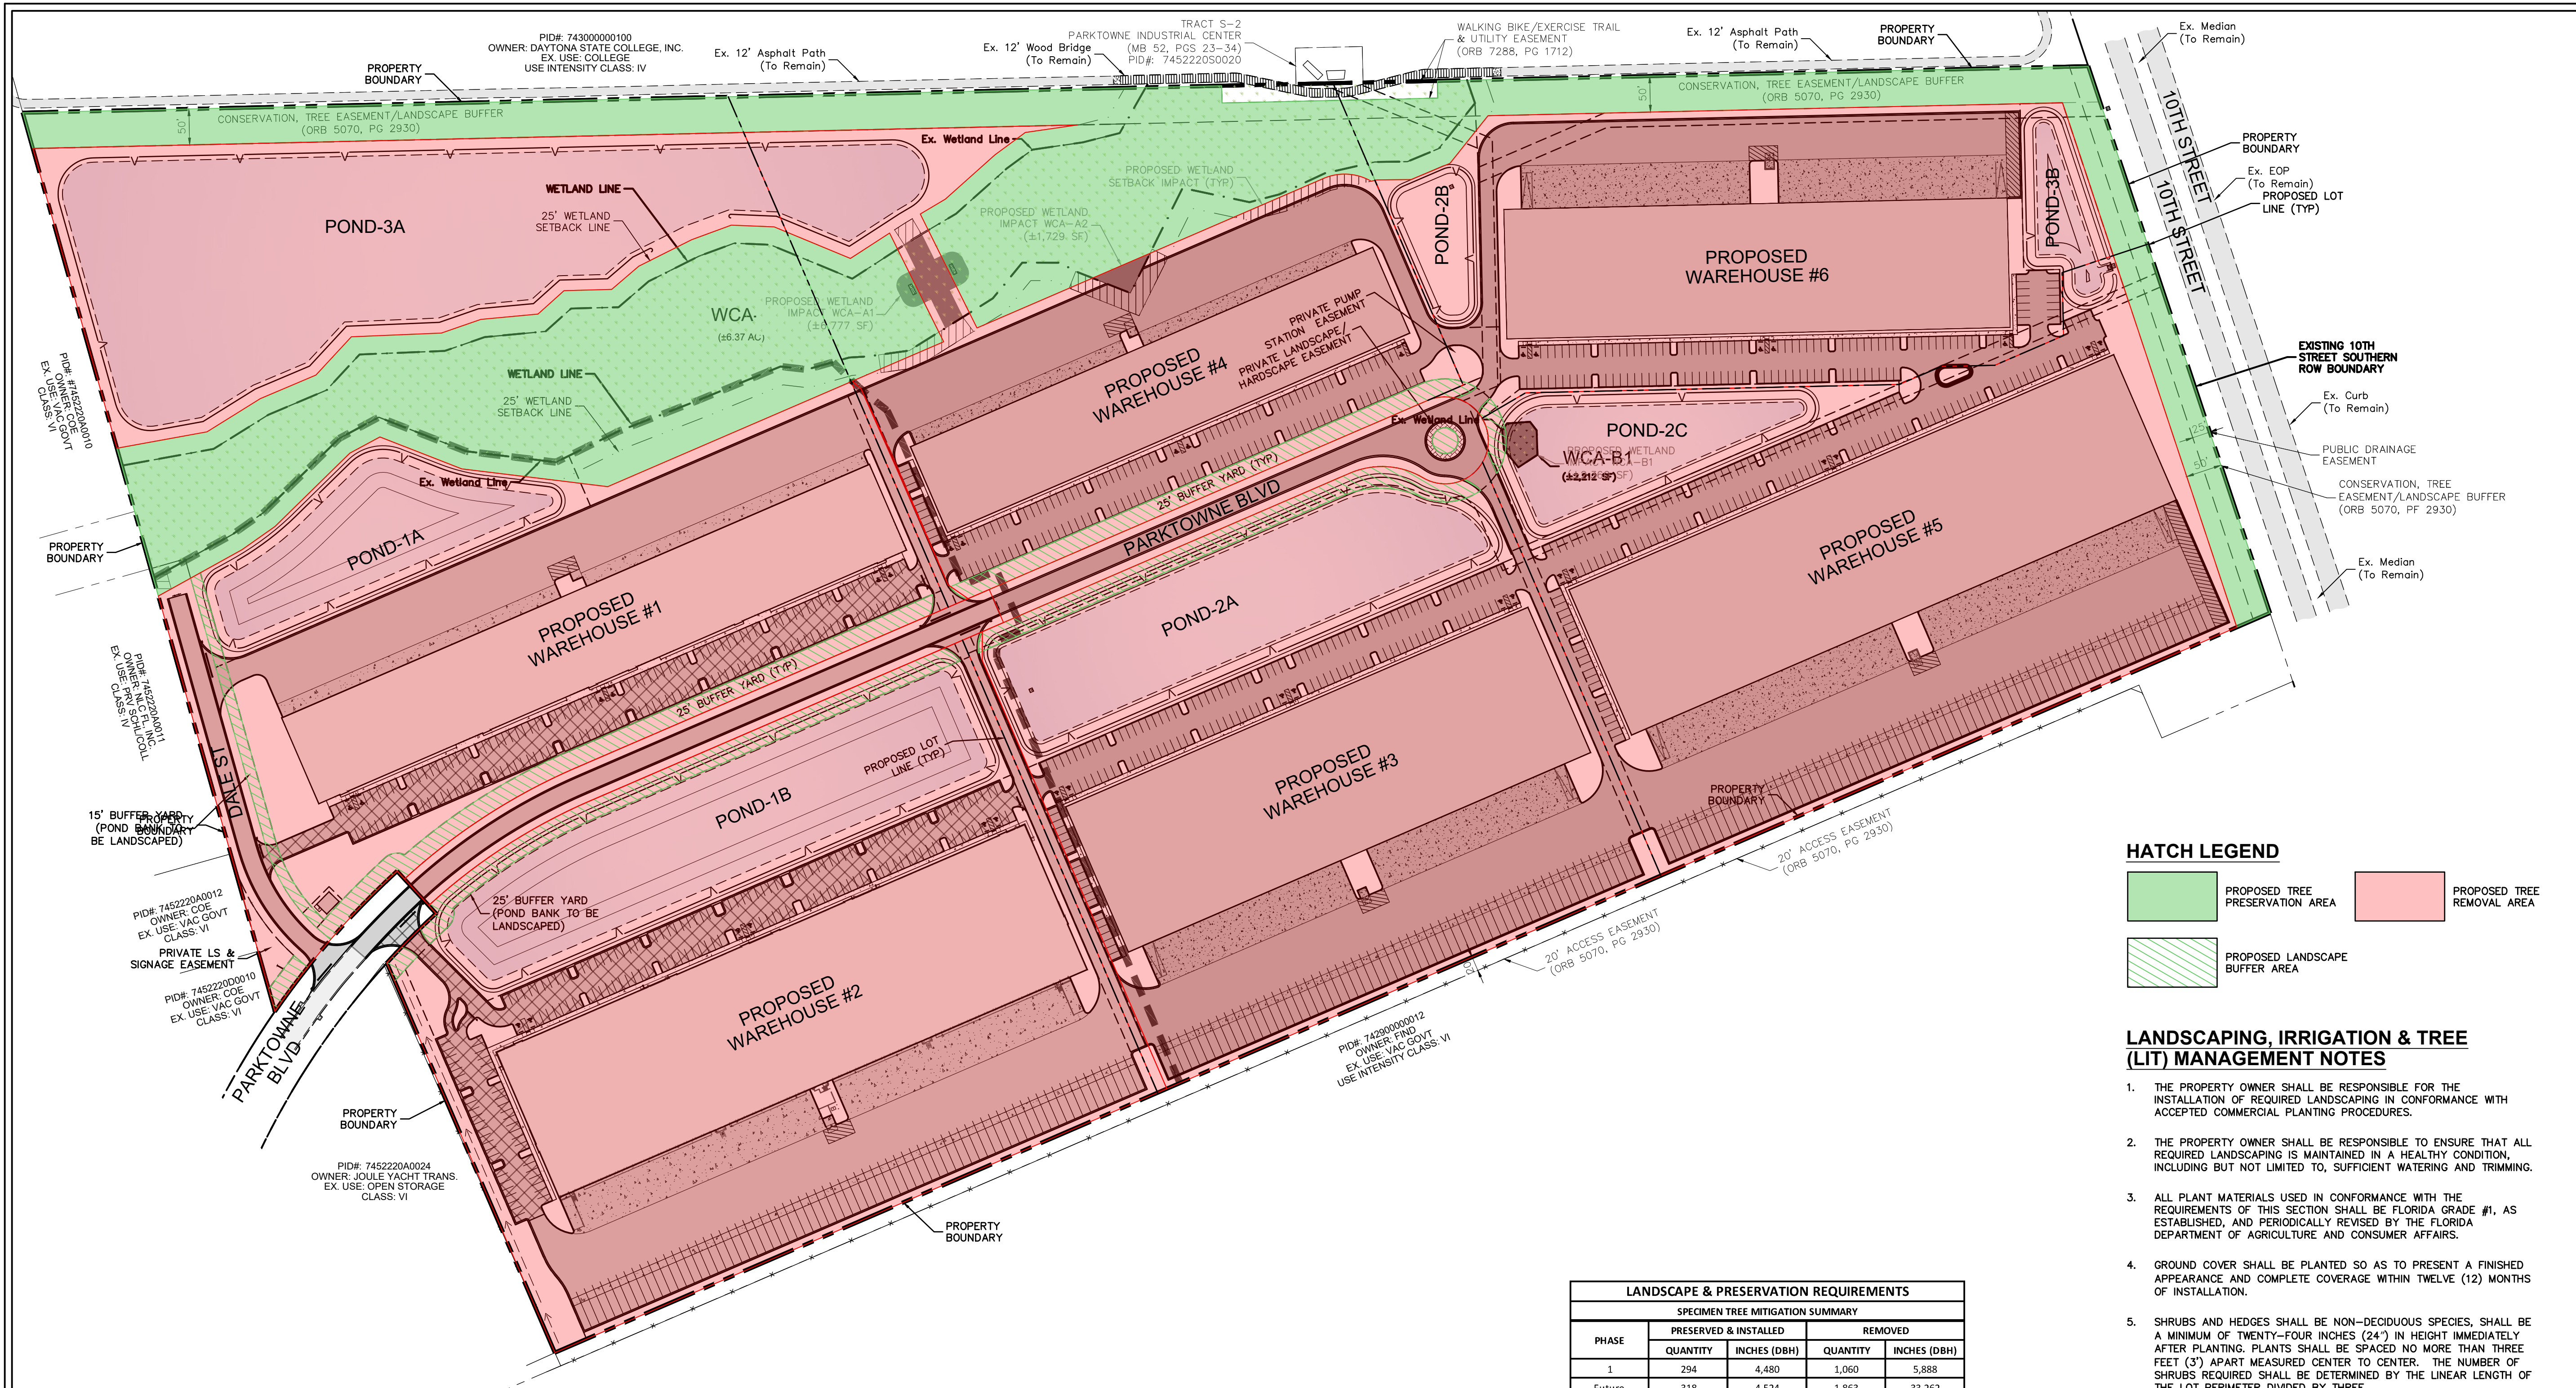

HATCH LEGEND

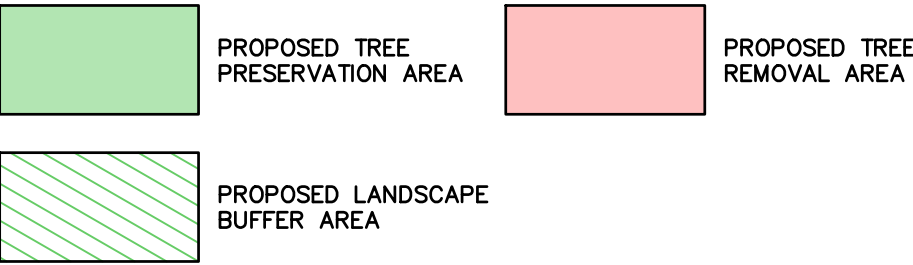

LANDSCAPING, IRRIGATION & TREE (LIT) MANAGEMENT NOTES


1. THE PROPERTY OWNER SHALL BE RESPONSIBLE FOR THE INSTALLATION OF REQUIRED LANDSCAPING IN CONFORMANCE WITH ACCEPTED COMMERCIAL PLANTING PROCEDURES.
2. THE PROPERTY OWNER SHALL BE RESPONSIBLE TO ENSURE THAT ALL REQUIRED LANDSCAPING IS MAINTAINED IN A HEALTHY CONDITION, INCLUDING BUT NOT LIMITED TO, SUFFICIENT WATERING AND TRIMMING.
3. ALL PLANT MATERIALS USED IN CONFORMANCE WITH THE REQUIREMENTS OF THIS SECTION SHALL BE FLORIDA GRADE #1, AS ESTABLISHED, AND PERIODICALLY REVISED BY THE FLORIDA DEPARTMENT OF AGRICULTURE AND CONSUMER AFFAIRS.
4. GROUND COVER SHALL BE PLANTED SO AS TO PRESENT A FINISHED APPEARANCE AND COMPLETE COVERAGE WITHIN TWELVE (12) MONTHS OF INSTALLATION.
5. SHRUBS AND HEDGES SHALL BE NON-DECIDUOUS SPECIES, SHALL BE A MINIMUM OF TWENTY-FOUR INCHES (24") IN HEIGHT IMMEDIATELY AFTER PLANTING. PLANTS SHALL BE SPACED NO MORE THAN THREE FEET (3') APART MEASURED CENTER TO CENTER. THE NUMBER OF SHRUBS REQUIRED SHALL BE DETERMINED BY THE LINEAR LENGTH OF THE LOT PERIMETER DIVIDED BY THREE.
6. SOD SHALL BE USED IN ROAD RIGHT-OF-WAYS, SWALES, STORMWATER MANAGEMENT AREAS AND OTHER AREAS SUBJECT TO EROSION. ALL NEW DEVELOPMENT OR EXPANSIONS MUST SOD ALL DISTURBED AREAS OF THE LOT PRIOR TO THE TIME THE CERTIFICATE OF OCCUPANCY IS ISSUED IN ACCORDANCE WITH ALL APPLICABLE REGULATORY AGENCY REQUIREMENTS.
7. LANDSCAPED AREAS REQUIRED BY THIS SECTION SHALL NOT USE EITHER THE TREES LISTED IN TABLE V-6 OR THE TREES LISTED IN TABLE V-2.
8. THE DEVELOPERS AGREEMENT (DA) SECTION 10.D.(1) - NO MIN. # OF TREES IS REQUIRED ON INDIVIDUAL PARCELS PROVIDED THE DEVELOPER MITIGATES HISTORIC INCHES REMOVED VIA REPLACEMENT OR TREE FUND PAYMENT.

| STATISTICAL TREE PRESERVATION & REMOVAL SUMMARY   |                   |          |              |          |              |           |              |              |          |              |   |                        |
|---|-------------------|----------|--------------|----------|--------------|-----------|--------------|--------------|----------|--------------|---|------------------------|
| LOT   | TREE PRESERVATION |          |              |          |              |           | TREE REMOVAL |              |          |              | PROPOSED LANDSCAPE BUFFERS & MITIGATION PLANTINGS |                        |
|   | AREA (AC)         | SPECIMEN |              | HISTORIC |              | AREA (AC) | SPECIMEN     |              | HISTORIC |              | BUFFER AREA (AC)                                  | BUFFER AREA (SF)       |
|   |                   | QUANTITY | INCHES (DBH) | QUANTITY | INCHES (DBH) |           | QUANTITY     | INCHES (DBH) | QUANTITY | INCHES (DBH) |   | (1 PER PARKING ISLAND) |
| 1   | 5.95              | 232      | 3,897        | 12       | 458          | 10.39     | 405          | 3,897        | 21       | 800          | 0.78  | 33,959                 |
| 2   | 0.00              | 0        | 0            | 0        | 0            | 14.11     | 550          | 0            | 28       | 1,086        | 0.51  | 22,264                 |
| *3  | 0.00              | 0        | 0            | 0        | 0            | 0.23      | 9            | 0            | 0        | 18           | 0.00  | 0                      |
| *4  | 0.00              | 0        | 0            | 0        | 0            | 0.09      | 4            | 0            | 0        | 7            | 0.00  | 0                      |
| ROW   | 0.00              | 0        | 0            | 0        | 0            | 1.04      | 41           | 0            | 2        | 80           | 0.00  | 0                      |
| PH-1 Subtotal   | 5.95              | 232      | 3,897        | 12       | 458          | 25.86     | 1,009        | 3,897        | 51       | 1,991        | 1.29  | 56,223                 |
| FUTURE PHASES   |                   |          |              |          |              |           |              |              |          |              |   |                        |
| **1   | 0.00              | 0        | 0            | 0        | 0            | 6.16      | 240          | 4,035        | 12       | 474          | 0.00  | 0                      |
| 3   | 3.66              | 143      | 2,397        | 7        | 282          | 11.60     | 452          | 7,598        | 23       | 893          | 0.43  | 18,857                 |
| 4   | 0.00              | 0        | 0            | 0        | 0            | 7.17      | 280          | 4,696        | 14       | 552          | 0.44  | 19,222                 |
| 5   | 0.62              | 24       | 406          | 1        | 48           | 11.63     | 454          | 7,618        | 23       | 896          | 0.05  | 2,151                  |
| 6   | 1.64              | 64       | 1,074        | 3        | 126          | 7.89      | 308          | 5,168        | 16       | 608          | 0.00  | 0                      |
| ROW   | 0.00              | 0        | 0            | 0        | 0            | 0.99      | 39           | 648          | 2        | 76           | 0.00  | 0                      |
| Future Subtotal   | 5.92              | 231      | 3,877        | 11       | 456          | 45.44     | 1,773        | 29,763       | 90       | 3,499        | 0.92  | 40,230                 |
| MDP TOTAL   | 11.87             | 463      | 7,774        | 23       | 914          | 71.30     | 2,782        | 33,660       | 141      | 5,490        | 2.21  | 96,453                 |
| * PAVEMENT AREAS & DAYLIGHT GRADING LOCATED OUTSIDE OF LOT 1 & 2 NECESSARY TO FACILITATE PHASE-1 INFRASTRUCTURE |                   |          |              |          |              |           |              |              |          |              |   |                        |
| ** POND-3A TO BE CONSTRUCTED IN FUTURE PHASES   |                   |          |              |          |              |           |              |              |          |              |   |                        |

| LANDSCAPE & PRESERVATION REQUIREMENTS   |                                  |  |                               |                                       |
|---|----------------------------------|--|-------------------------------|---------------------------------------|
| PHASE   | SPECIMEN TREE MITIGATION SUMMARY |  |                               |                                       |
|   | PRESERVED & INSTALLED            |  | REMOVED                       |                                       |
|   | QUANTITY                         | INCHES (DBH)                           | QUANTITY                      | INCHES (DBH)                          |
| 1   | 294                              | 4,480                                  | 1,060                         | 5,888                                 |
| Future  | 318                              | 4,524                                  | 1,863                         | 33,262                                |
| Total MDP   | 612                              | 9,004                                  | 2,923                         | 39,150                                |
| AREA TREE PROTECTION REQUIREMENTS - (SEC. 21-55.08)   |                                  |  |                               |                                       |
| PHASE   | PRESERVED AREA (AC)              | LANDSCAPE BUFFER AREA (AC)             | TOTAL (AC)                    | %                                     |
| 1   | 5.95                             | 1.29                                   | 37.66                         | 19.23%                                |
| Future  | 5.92                             | 0.92                                   | 45.69                         | N/A                                   |
| Total MDP   | 11.87                            | 2.21                                   | 83.35                         | 16.90%                                |
| Required Area Tree Protection Zone:   |                                  |  |                               | 15.00%                                |
| * As Future Phases are Permitted Developer is Required to Demonstrate 15% Min. Area Tree Protection Requirement is Met. |                                  |  |                               |                                       |
| PROPOSED LANDSCAPING INSTALLATION REQUIREMENTS  |                                  |  |                               |                                       |
| LOT   | PERIMETER (LF)                   | REQUIRED HEDGES/SHRUB S (24"H/3' O.C.) | PROPOSED PARKING ISLANDS (EA) | PROPOSED SPECIMEN TREE PLANTINGS (EA) |
| 1   | 4,175                            | 1,392                                  | 22                            | 22                                    |
| 2   | 3,132                            | 1,044                                  | 28                            | 28                                    |
| 3   | 2,861                            | 954                                    | 20                            | 20                                    |
| 4   | 2,850                            | 950                                    | 19                            | 19                                    |
| 5   | 3,197                            | 1,066                                  | 19                            | 19                                    |
| 6   | 2,953                            | 984                                    | 18                            | 18                                    |
| Total MDP   | 19,168                           | 6,390                                  | 126                           | 126                                   |

Project Name  
**SPACE COAST COMMERCE PARK @ PARKTOWNE**  
CITY OF EDGEWATER, FL

Prepared For  
**ONIX MANAGEMENT GROUP, LLC**

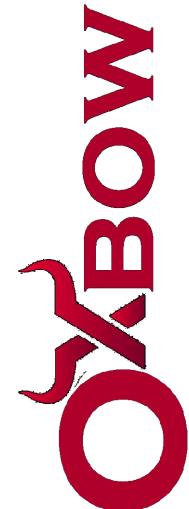

4206 NATIONAL GUARD DRIVE, #1  
PLANT CITY, FL 33563  
Phone (813) 857-7024 Web www.oxboweng.com  
FL Registry 36174

Project No.: 1001-002  
Issued: AUG 21, 2023  
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Checked By: MJS  
Scale: 1" = 120'  
Sheet Title  
**MASTER DEVELOPMENT LIT MANAGEMENT PLAN**  
Sheet Number  
**C-03**



|              |              |
|--------------|--------------|
| Project No.: | 1001-002     |
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| Scale:       | 1" = 120'    |

Sheet Title

**MASTER  
DEVELOPMENT  
SITE PLAN**

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Sheet Number

**C-04**




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Emilio Cabrera

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8/22/2023



### FLOODPLAIN IMPACT & COMPENSATION SUMMARY

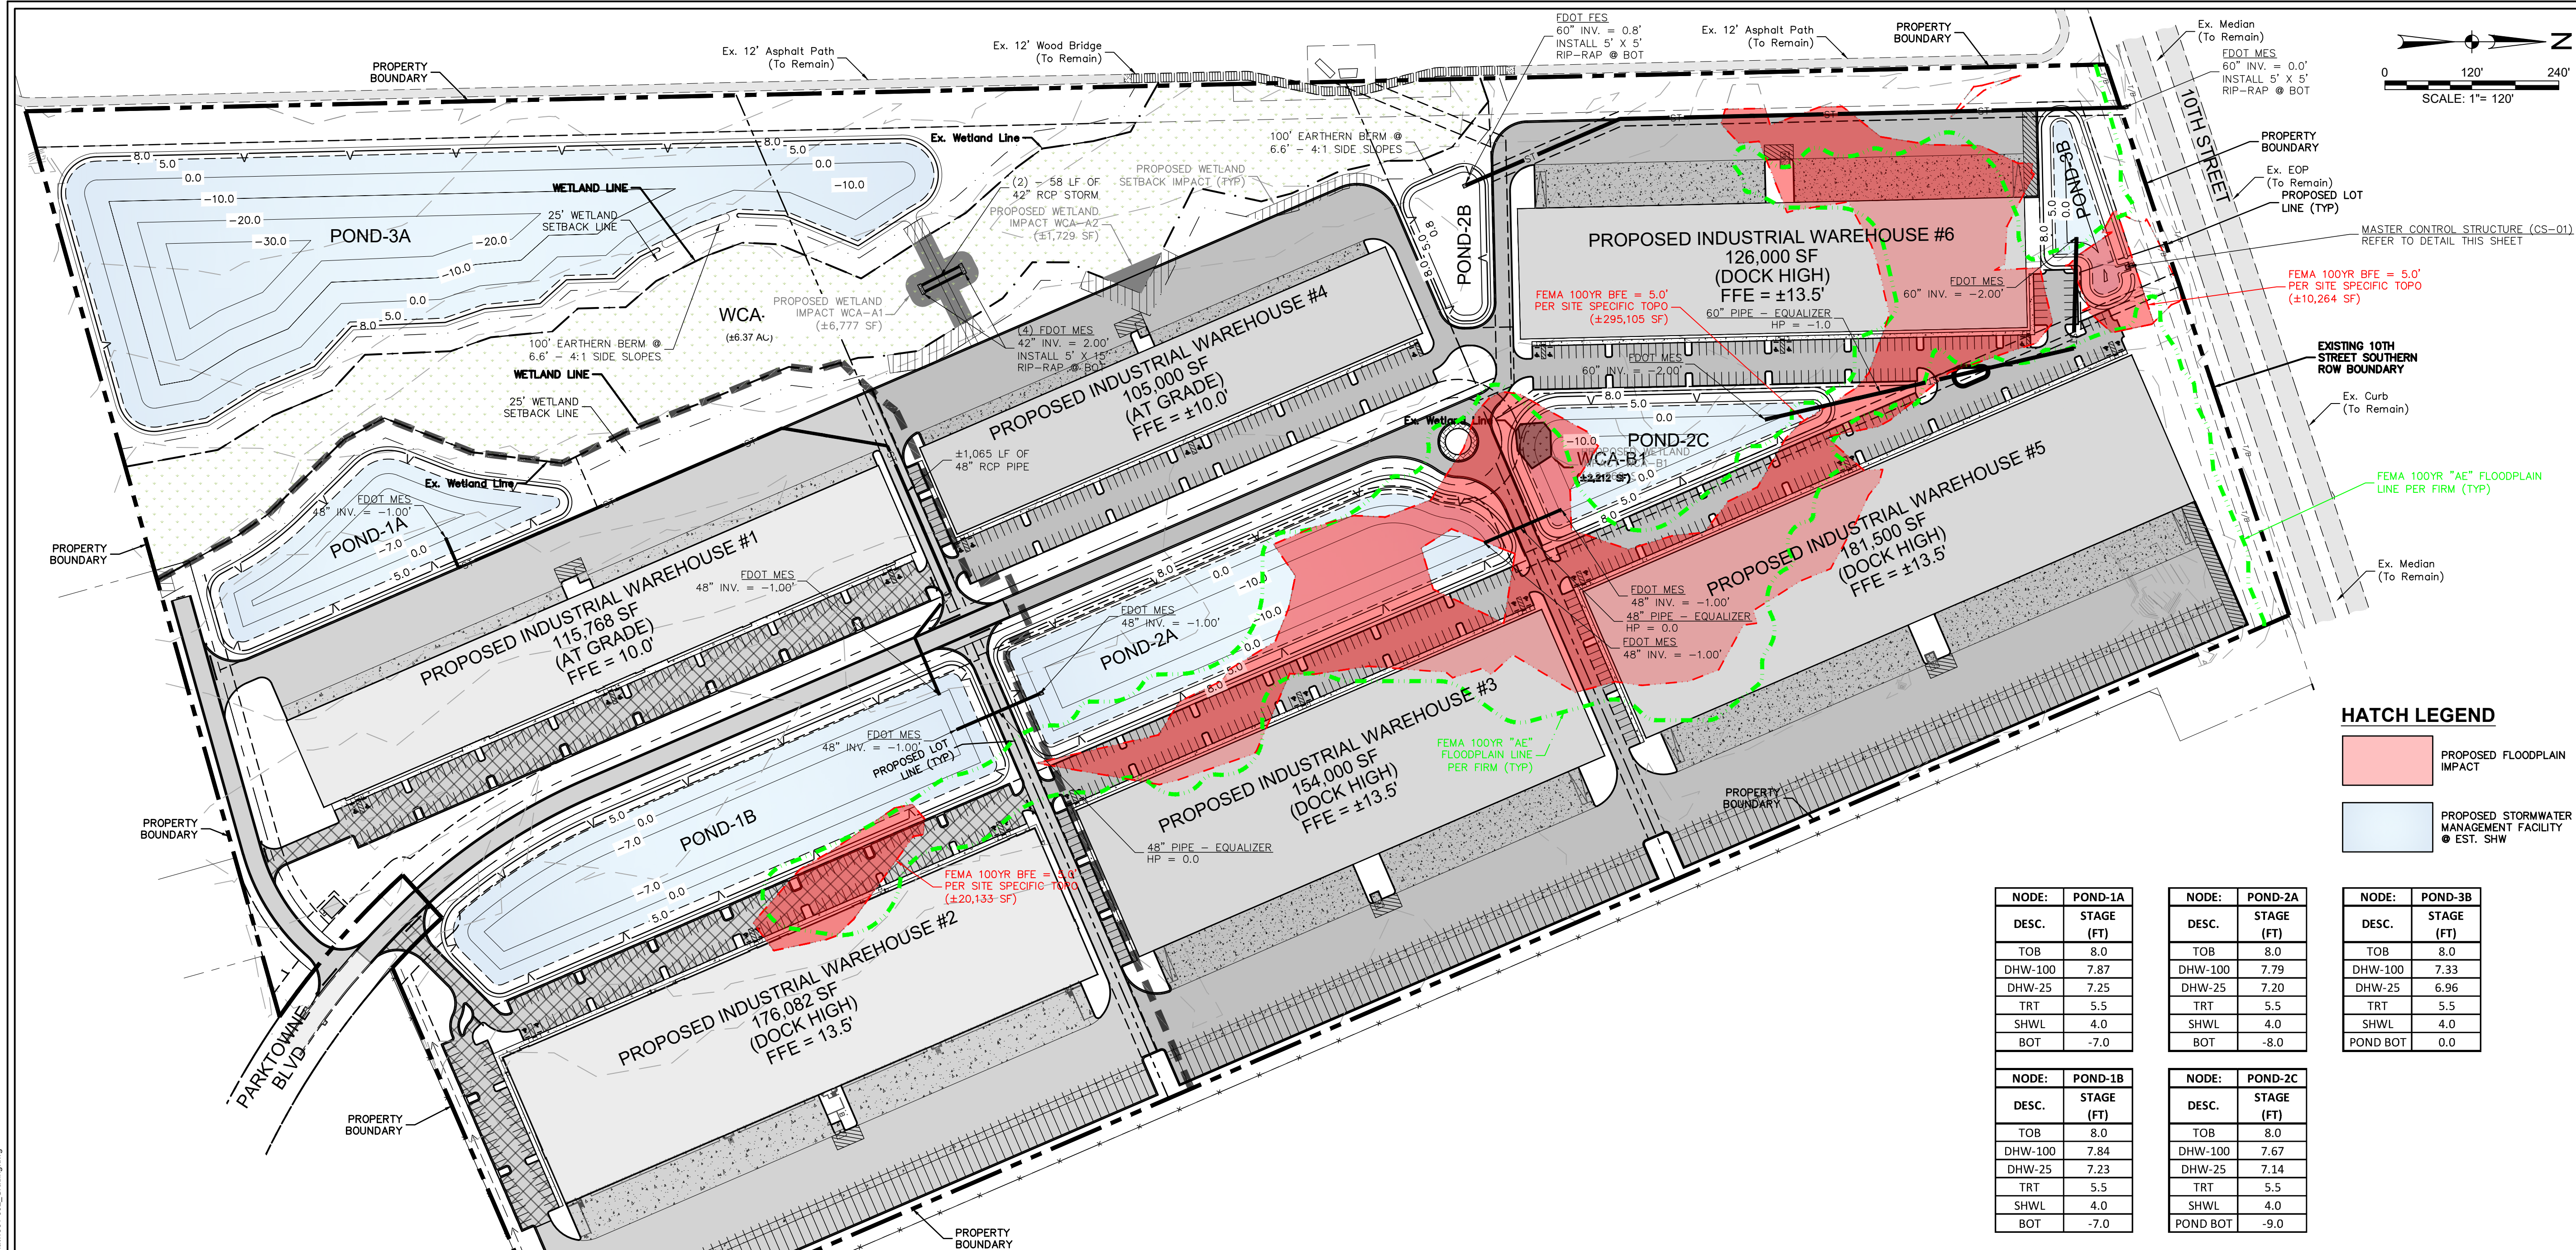
- FLOOD ZONE: THE PROPERTY IS LOCATED IN FLOOD ZONE "AE" (BFE=5.0'), "X"-SHADED & "X" PER FEMA FLOOD INSURANCE RATE MAP (FIRM) NO. 12127C0543J, EFFECTIVE SEPT. 29, 2017.
- PROPOSED FLOODPLAIN IMPACT AREAS:  
PHASE-1 = ±20,133 SF (0.46 AC)  
FUTURE PHASE(S) = ±305,369 SF (7.01 AC)  
TOTAL = ±325,502 SF (7.47 AC)
- FLOODPLAIN COMPENSATION - COMPENSATION IS PROVIDED WITHIN THE ON-SITE STORMWATER MANAGEMENT FACILITIES TO DEMONSTRATE BOTH PEAK STAGE AND DISCHARGE TO UPSTREAM AND DOWNSTREAM CRITICAL NODES IS EQUAL TO OR LESS THAN THE PRE-DEVELOPMENT CONDITIONS FOR ALL STORM EVENTS UP TO AND INCLUDING THE 100YR DESIGN STORM. PLEASE REFER TO THE DRAINAGE REPORT FOR DETAILED INFORMATION.
- A CUP FOR CUP VOLUMETRIC ANALYSIS IS PROVIDED FOR PHASE-1 IMPACTS TO VERIFY COMPLIANCE WITH CITY OF EDGEWATER REQUIREMENTS

| Phase 1 - Floodplain Impact |           |             |
|-----------------------------|-----------|-------------|
| Stage (FT)                  | Area (SF) | Volume (CF) |
| 5                           | 20,133    | 3,035       |
| 4.7                         | 100       | 0           |


| Phase 1 - Floodplain Compensation - Pond 1B Outfall |           |             |
|---|-----------|-------------|
| Stage (FT)  | Area (SF) | Volume (CF) |
| 5   | 7,396     | 6,674       |
| 4   | 5,952     | 0           |

100YR  
SHWL

### FLOODPLAIN IMPACT AND COMPENSATION ANALYSIS

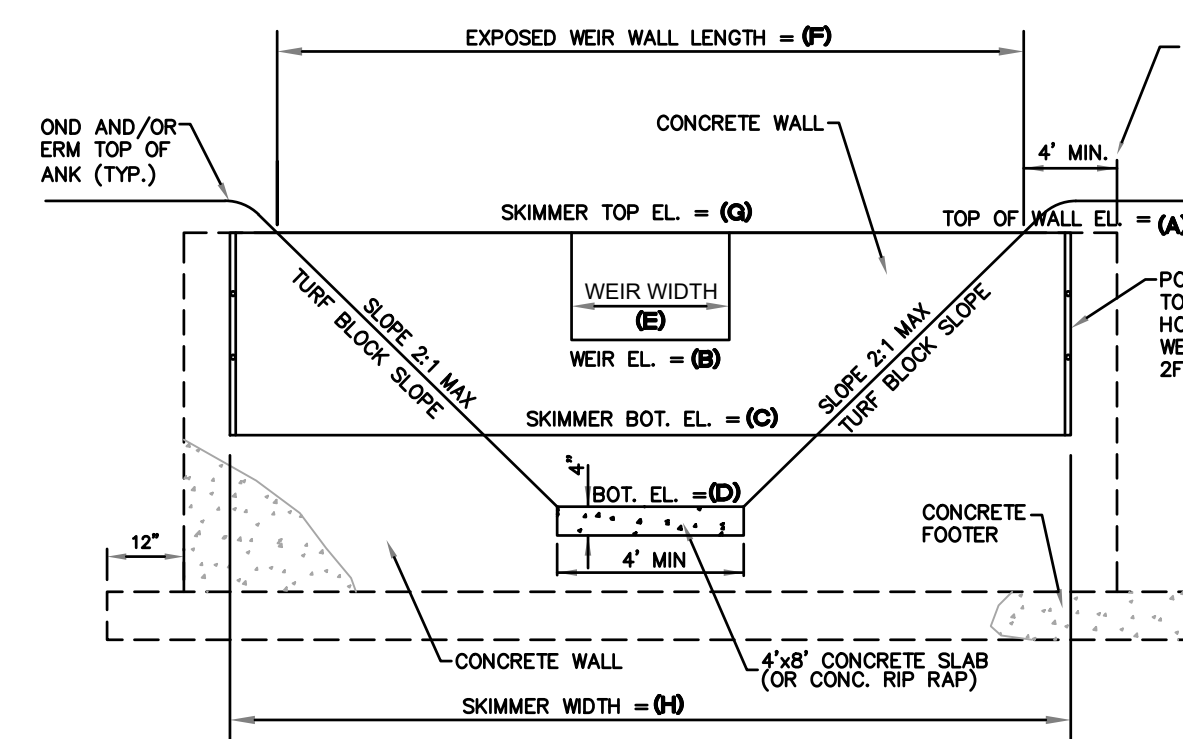

FRONT (UPSTREAM POND SIDE)  
SECTIONAL ELEVATION

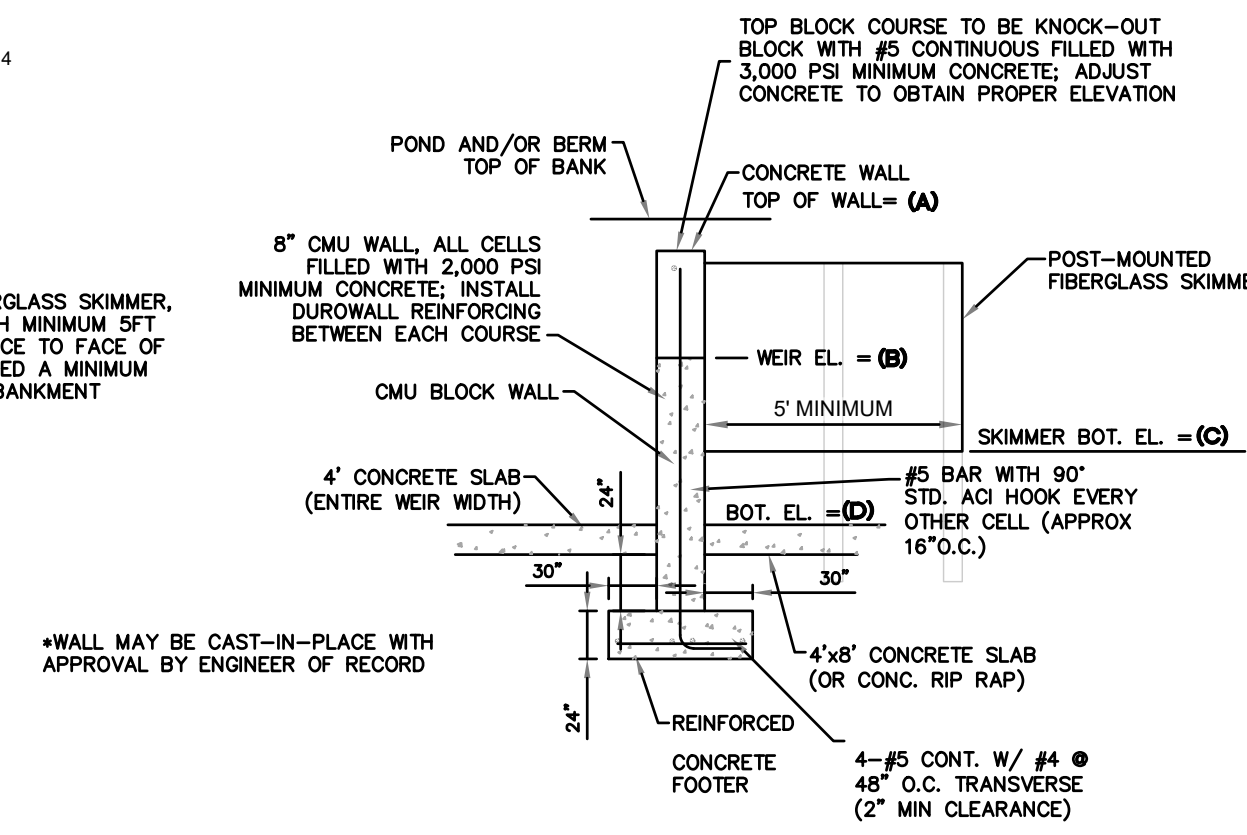

TYPICAL SECTION

| STRUCTURE NUMBER | A    | B    | C    | D    | E   | F   | G    | H   | NOTES             |
|------------------|------|------|------|------|-----|-----|------|-----|-------------------|
| CS-01            | 8.0' | 5.5' | 4.5' | 3.0' | 12' | 32± | 8.0' | 36± | MASTER CS POND-3B |

WEIR WALL DIMENSION TABLE  
N.T.S.

### CS-01 WEIR WALL DETAILS

N.T.S.

### MASTER POST DEVELOPMENT POND DATA

| NODE:   | POND-1A    |
|---------|------------|
| DESC.   | STAGE (FT) |
| TOB     | 8.0        |
| DHW-100 | 7.87       |
| DHW-25  | 7.25       |
| TRT     | 5.5        |
| SHWL    | 4.0        |
| BOT     | -7.0       |

| NODE:   | POND-2A    |
|---------|------------|
| DESC.   | STAGE (FT) |
| TOB     | 8.0        |
| DHW-100 | 7.79       |
| DHW-25  | 7.20       |
| TRT     | 5.5        |
| SHWL    | 4.0        |
| BOT     | -8.0       |

| NODE:    | POND-3B    |
|----------|------------|
| DESC.    | STAGE (FT) |
| TOB      | 8.0        |
| DHW-100  | 7.33       |
| DHW-25   | 6.96       |
| TRT      | 5.5        |
| SHWL     | 4.0        |
| POND BOT | 0.0        |

| NODE:   | POND-1B    |
|---------|------------|
| DESC.   | STAGE (FT) |
| TOB     | 8.0        |
| DHW-100 | 7.84       |
| DHW-25  | 7.23       |
| TRT     | 5.5        |
| SHWL    | 4.0        |
| BOT     | -7.0       |

| NODE:    | POND-2C    |
|----------|------------|
| DESC.    | STAGE (FT) |
| TOB      | 8.0        |
| DHW-100  | 7.67       |
| DHW-25   | 7.14       |
| TRT      | 5.5        |
| SHWL     | 4.0        |
| POND BOT | -9.0       |

BACK (DOWNSTREAM DITCH SIDE)  
SECTIONAL ELEVATION

### HATCH LEGEND

|  |   |
|--|---|
|  | PROPOSED FLOODPLAIN IMPACT                            |
|  | PROPOSED STORMWATER MANAGEMENT FACILITY<br>● EST. SHW |

Project Name  
**SPACE COAST COMMERCE PARK  
@ PARKTOWNE**  
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**Oxbow**

4206 NATIONAL GUARD DRIVE, #1  
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FL Registry 36174 FL L22000260419

| Revision No. | Date | Description |
|--------------|------|-------------|
|              |      |             |
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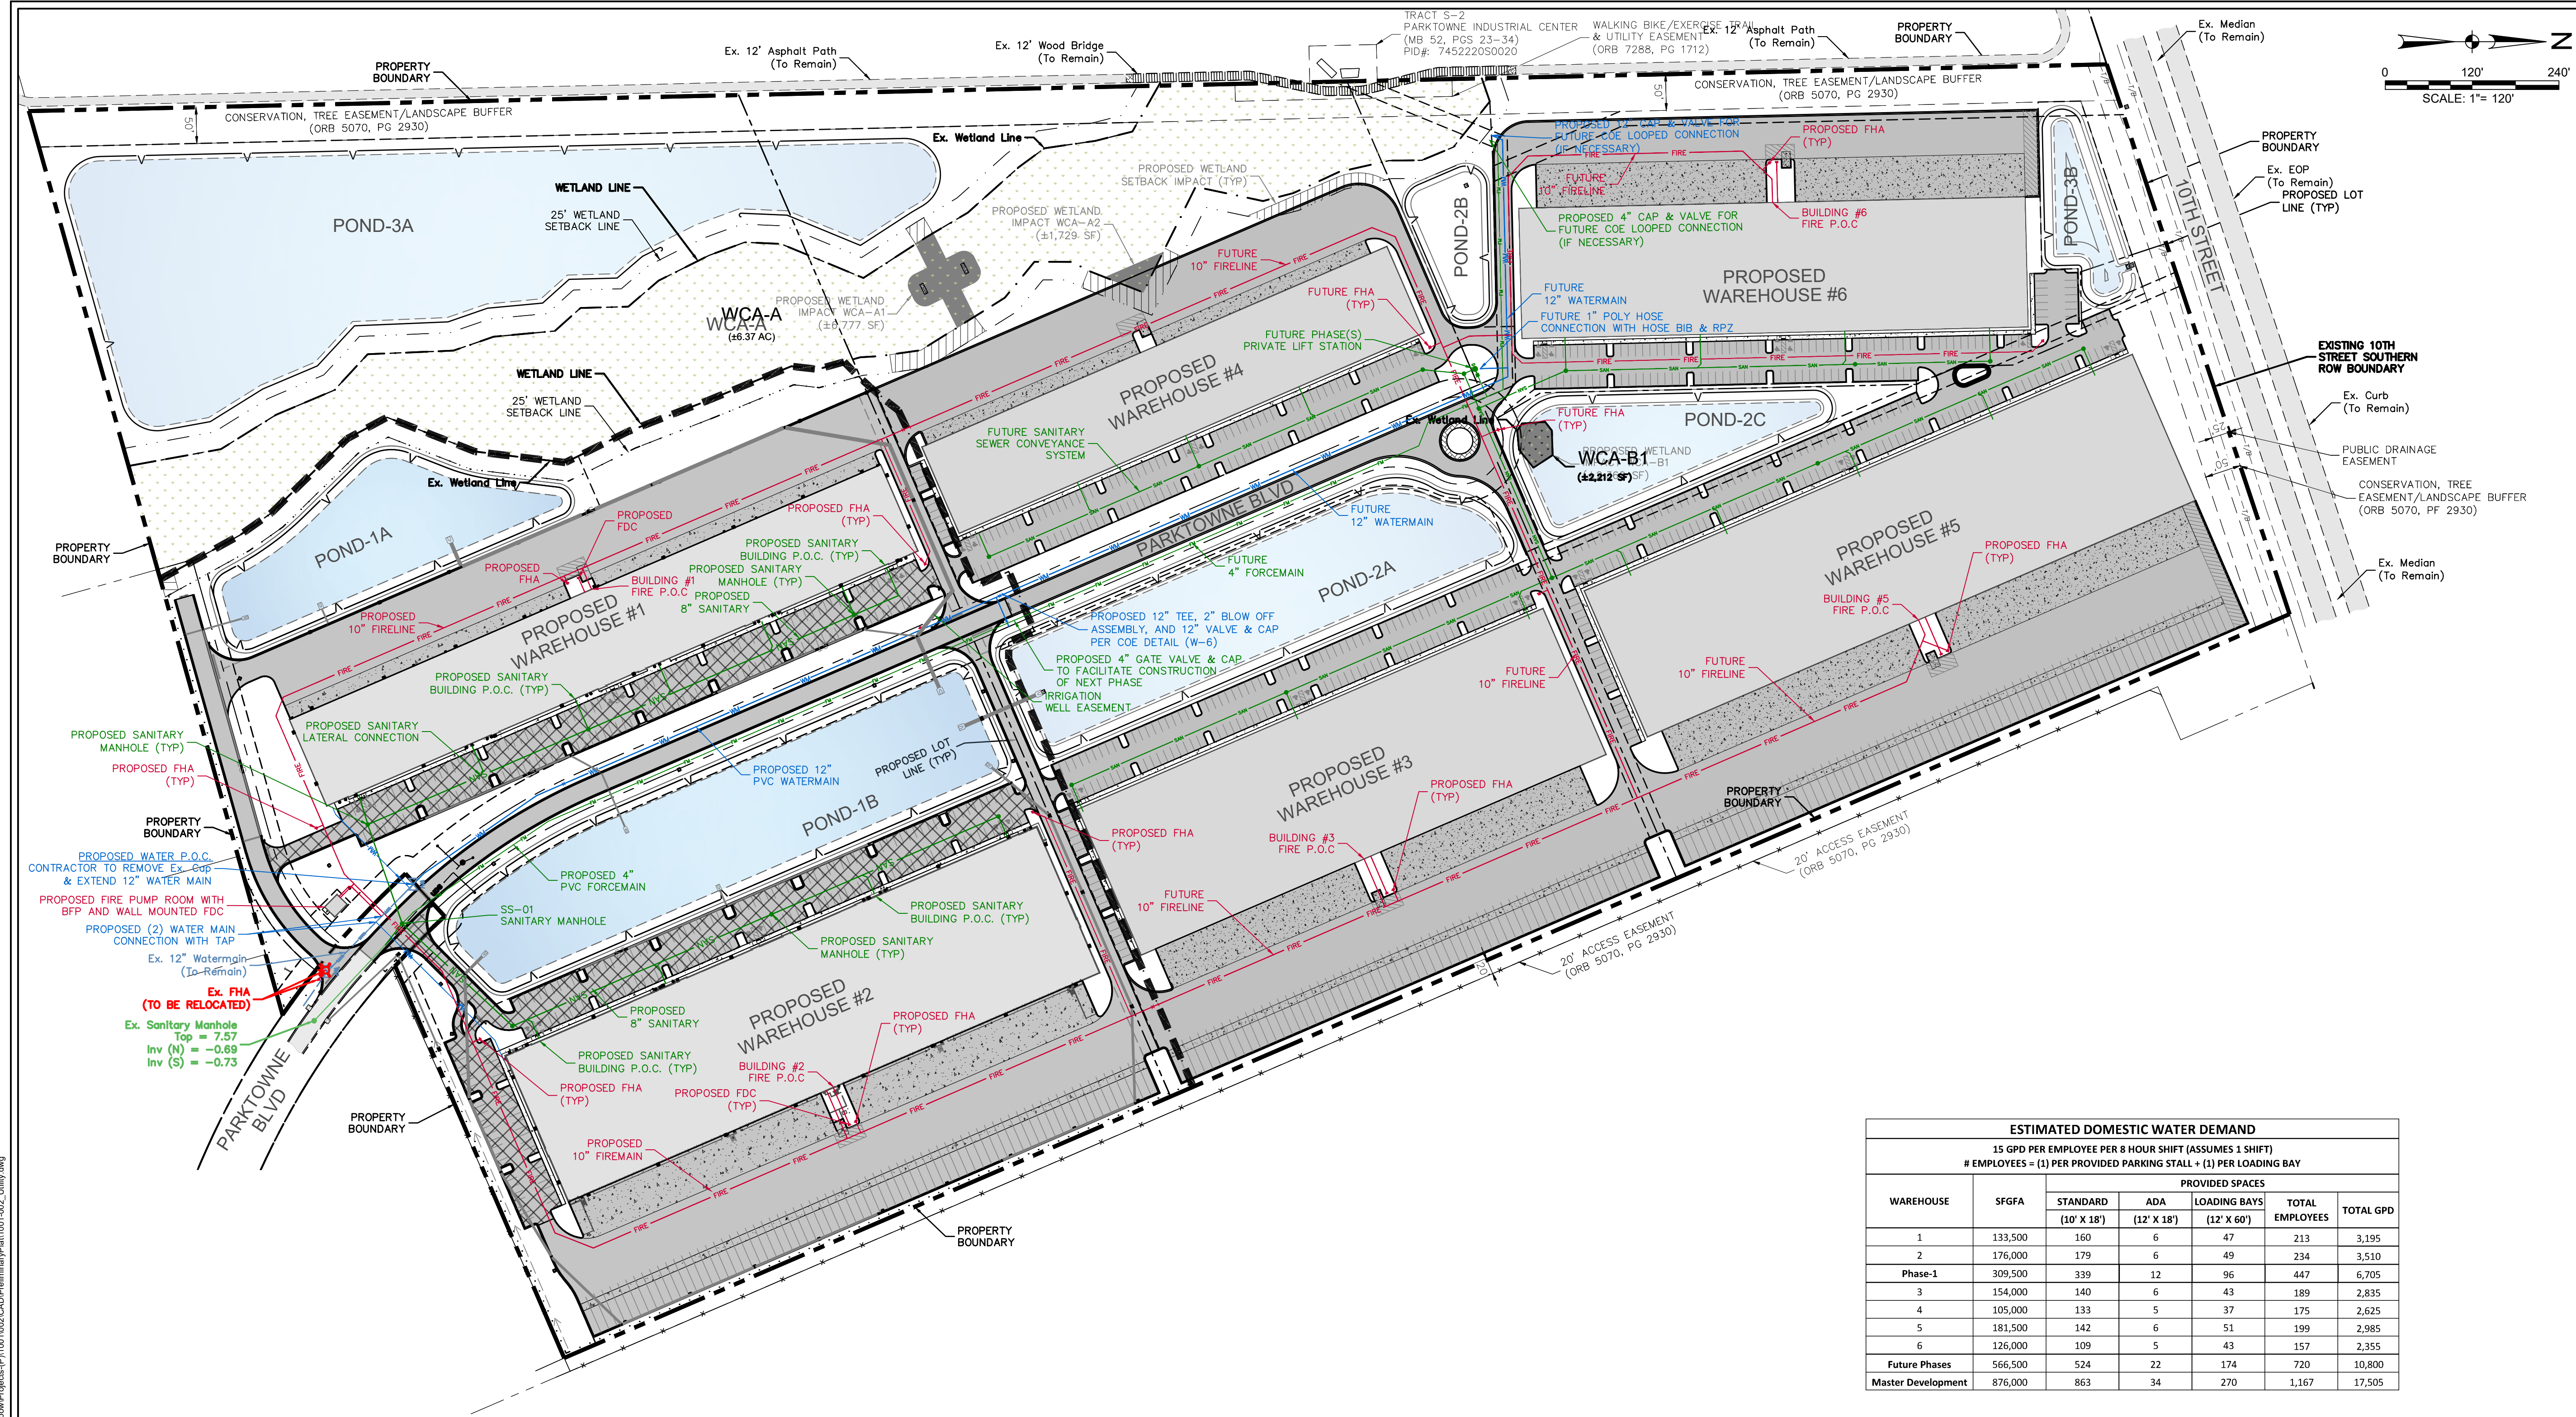
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| Project No.: | 1001-002     |
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| Checked By:  | MJS          |
| Scale:       | 1" = 120'    |

Sheet Title  
**MASTER DEVELOPMENT  
PGD PLAN**

Sheet Number

**C-05**





| ESTIMATED DOMESTIC WATER DEMAND                                    |         |                         |                    |                             |                    |
|--|---------|-------------------------|--------------------|-----------------------------|--------------------|
| 15 GPD PER EMPLOYEE PER 8 HOUR SHIFT (ASSUMES 1 SHIFT)             |         |                         |                    |                             |                    |
| # EMPLOYEES = (1) PER PROVIDED PARKING STALL + (1) PER LOADING BAY |         |                         |                    |                             |                    |
| WAREHOUSE  | SFGFA   | PROVIDED SPACES         |                    |                             |                    |
|  |         | STANDARD<br>(10' X 18') | ADA<br>(12' X 18') | LOADING BAYS<br>(12' X 60') | TOTAL<br>EMPLOYEES |
| 1  | 133,500 | 160                     | 6                  | 47                          | 213                |
| 2  | 176,000 | 179                     | 6                  | 49                          | 234                |
| Phase-1  | 309,500 | 339                     | 12                 | 96                          | 447                |
| 3  | 154,000 | 140                     | 6                  | 43                          | 189                |
| 4  | 105,000 | 133                     | 5                  | 37                          | 175                |
| 5  | 181,500 | 142                     | 6                  | 51                          | 199                |
| 6  | 126,000 | 109                     | 5                  | 43                          | 157                |
| Future Phases  | 566,500 | 524                     | 22                 | 174                         | 720                |
| Master Development   | 876,000 | 863                     | 34                 | 270                         | 1,167              |
|  |         |                         |                    |                             | 17,505             |

Project Name

SPACE COAST COMMERCE PARK  
@ PARKTOWNE  
CITY OF EDGEWATER, FL

Prepared For

ONIX MANAGEMENT GROUP, LLC

Revision

No.

Date

Description

Seal

MICHAEL J. SANDERS, JR., P.E.  
License Number: 76918

Project No.:

1001-002

Issued:

AUG 21, 2023

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ECC

Checked By:

MJS

Scale:

1" = 120'





Sheet Title

MASTER  
DEVELOPMENT  
UTILITY PLAN

Sheet Number

C-06



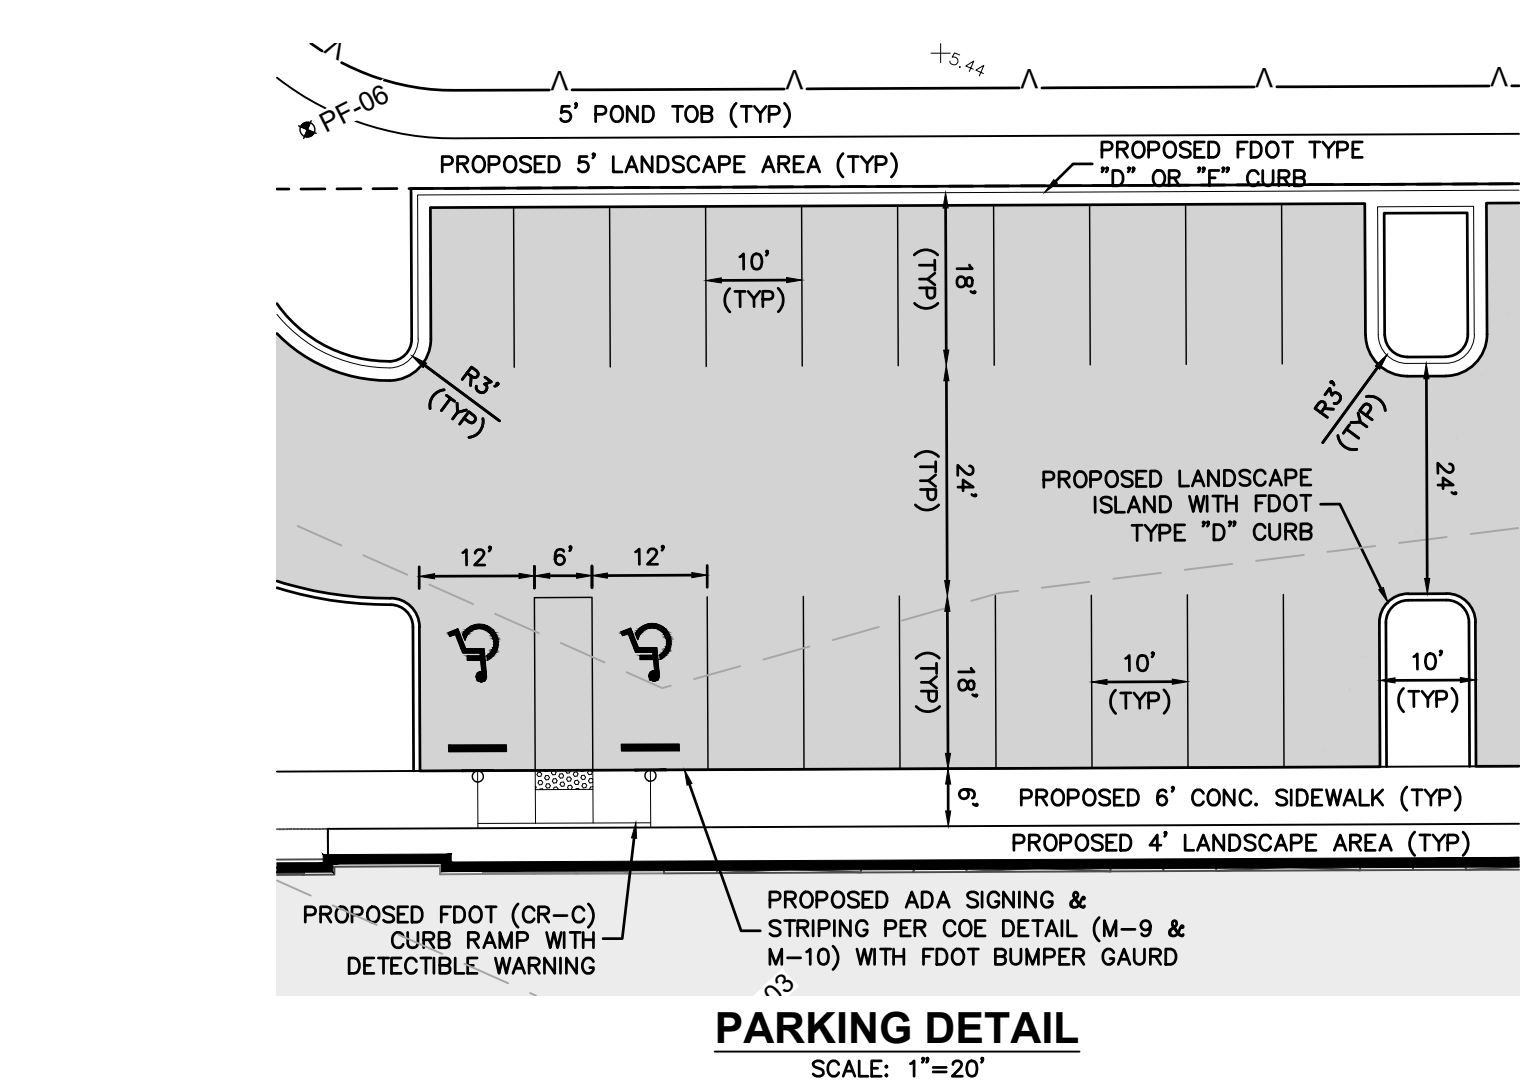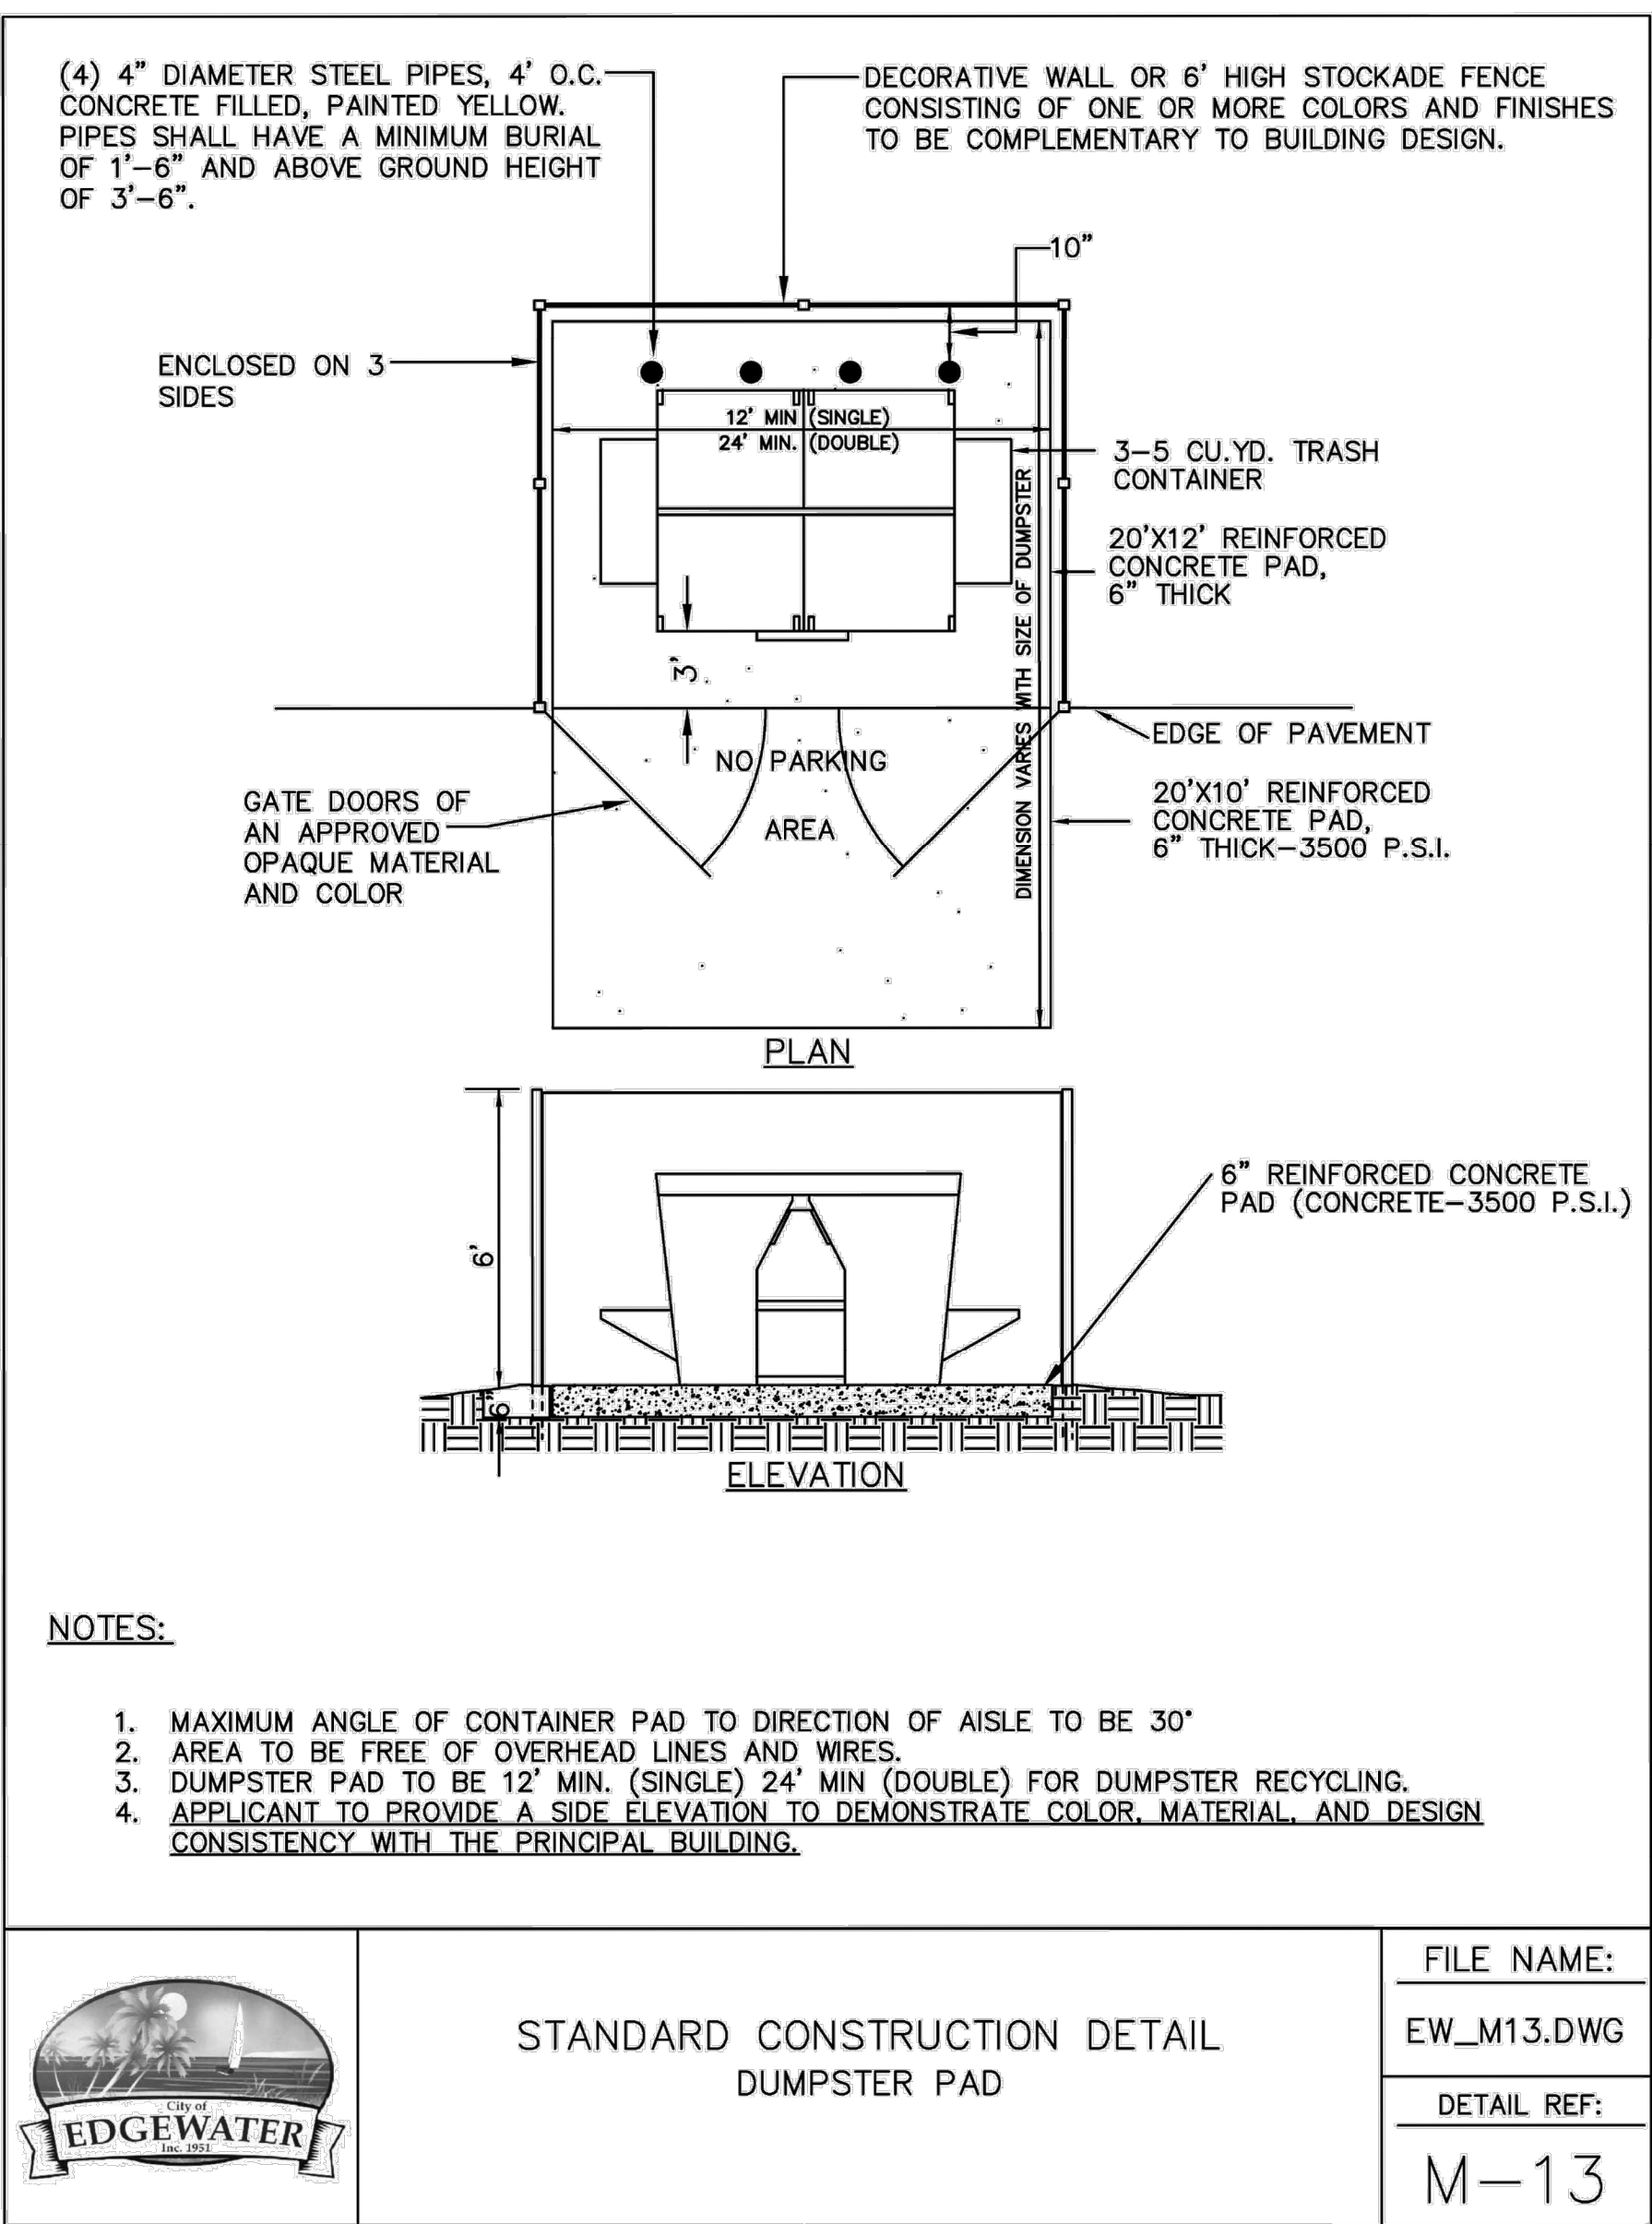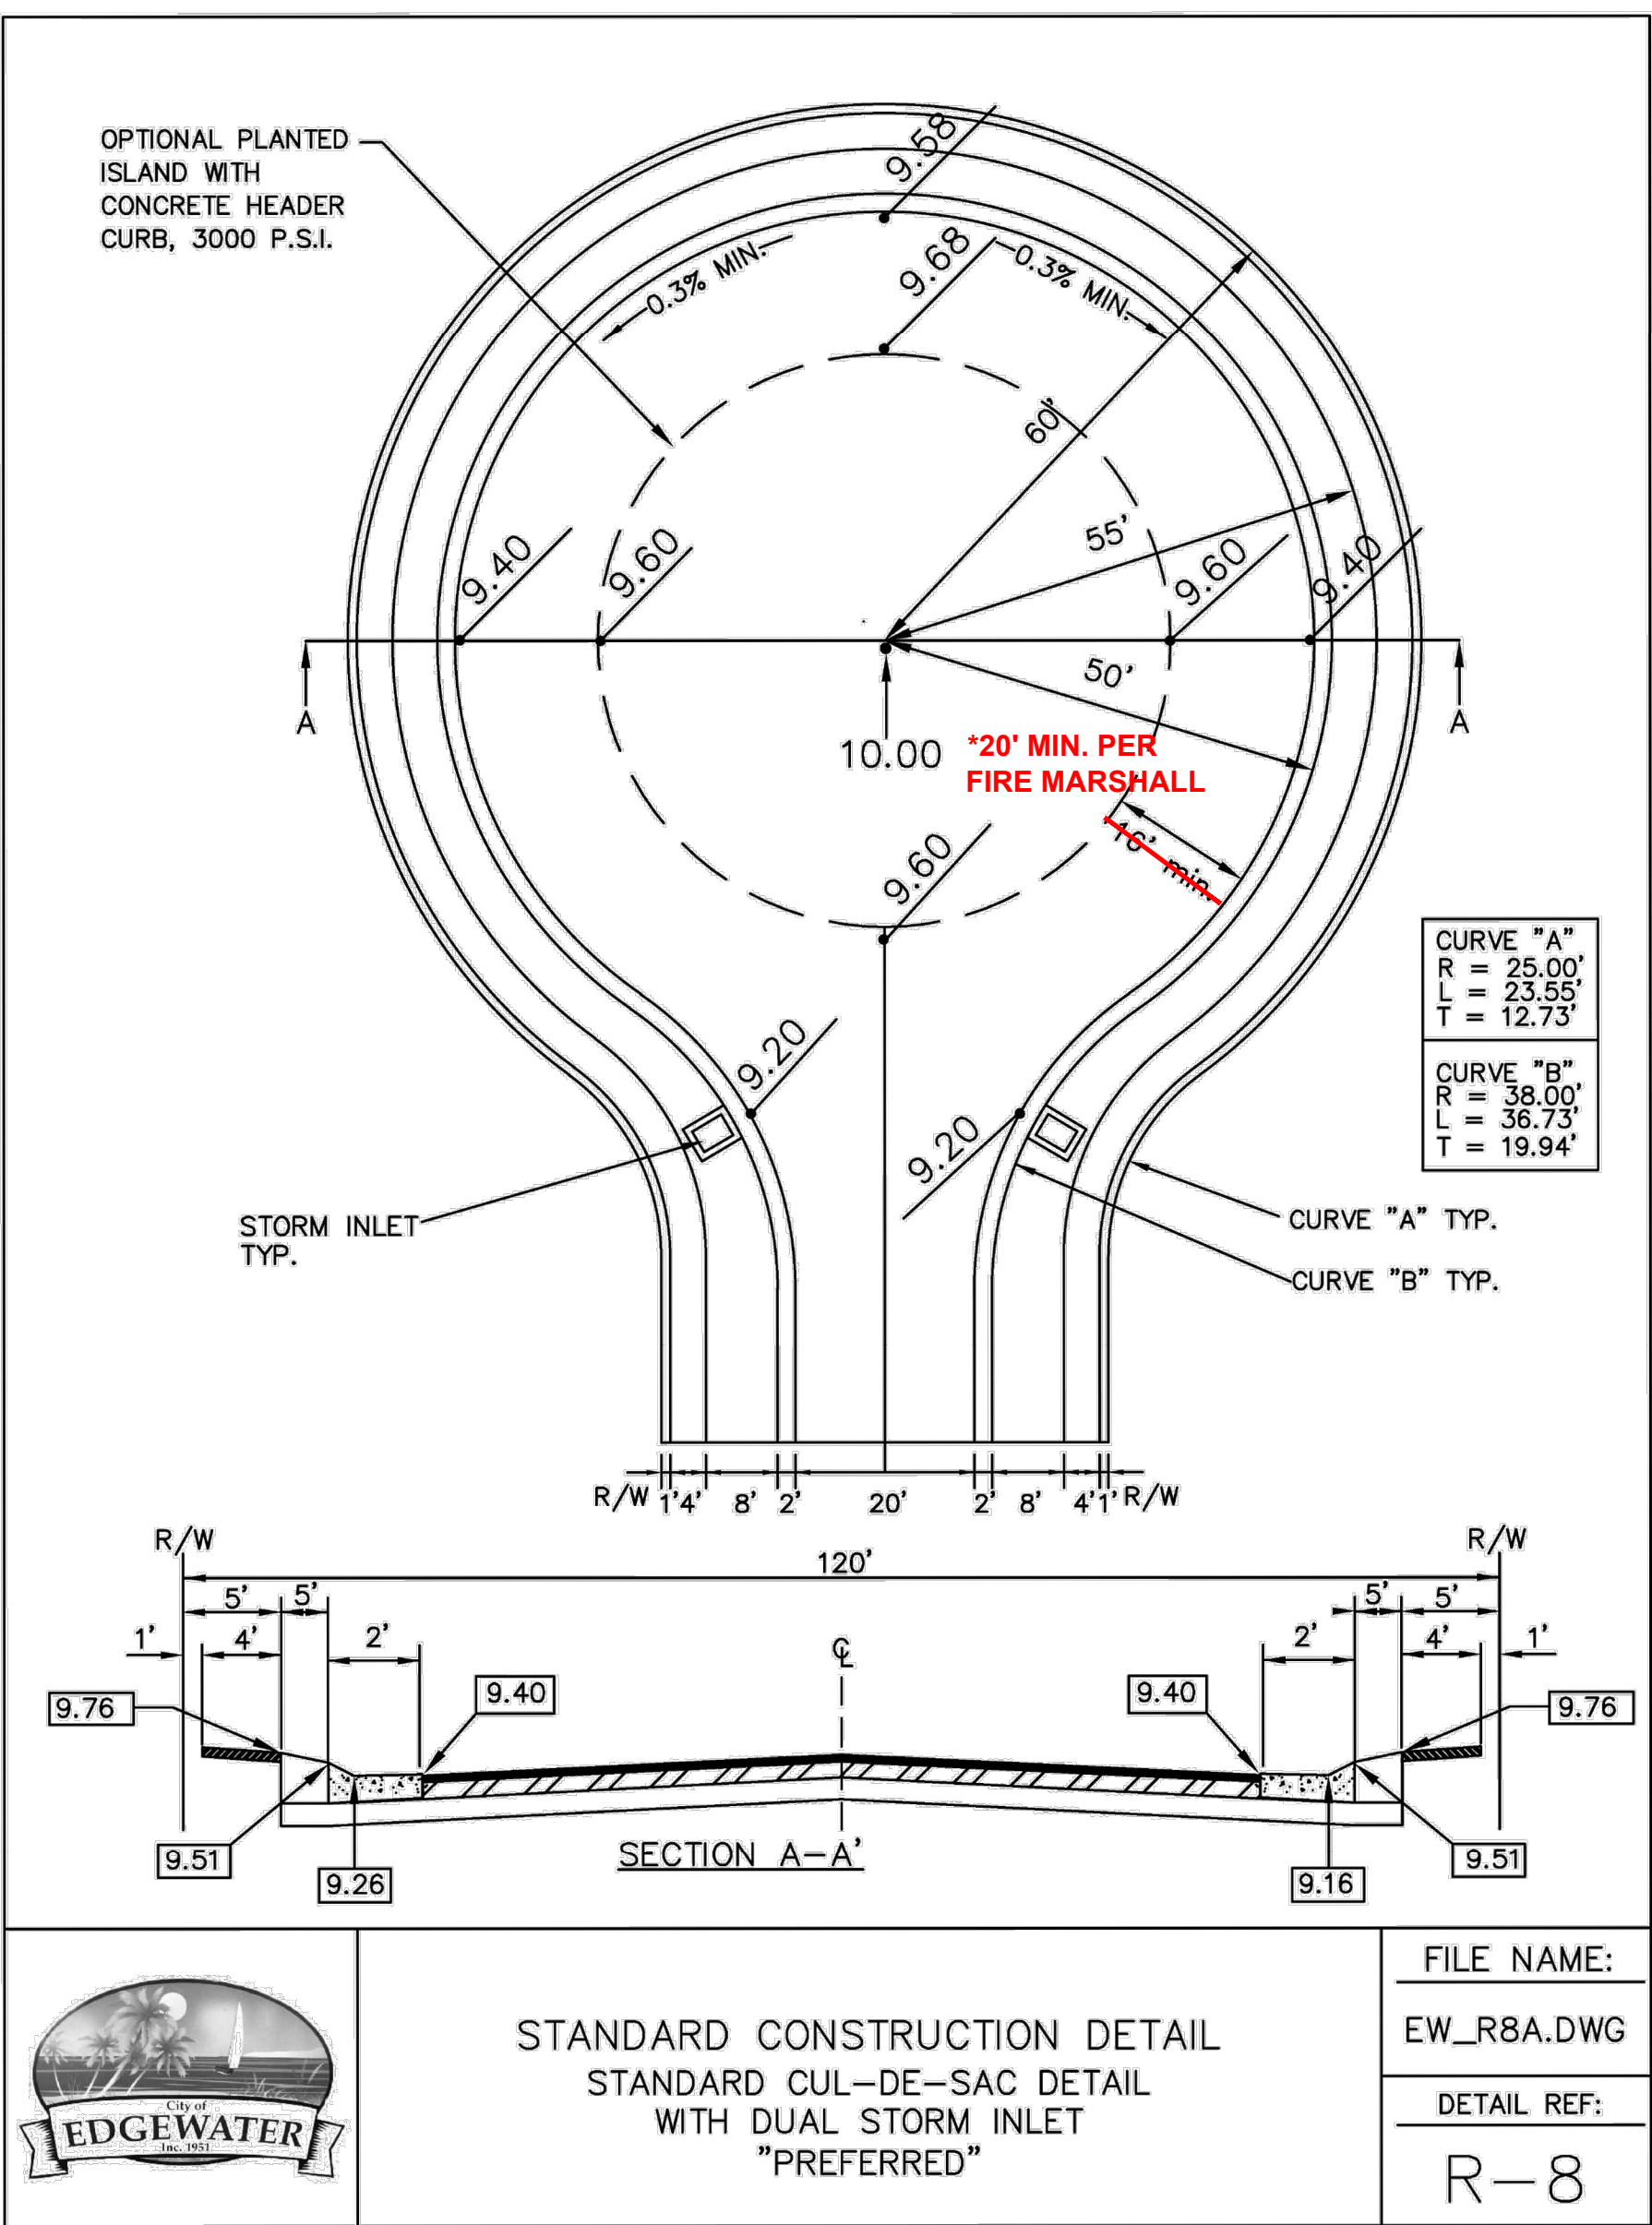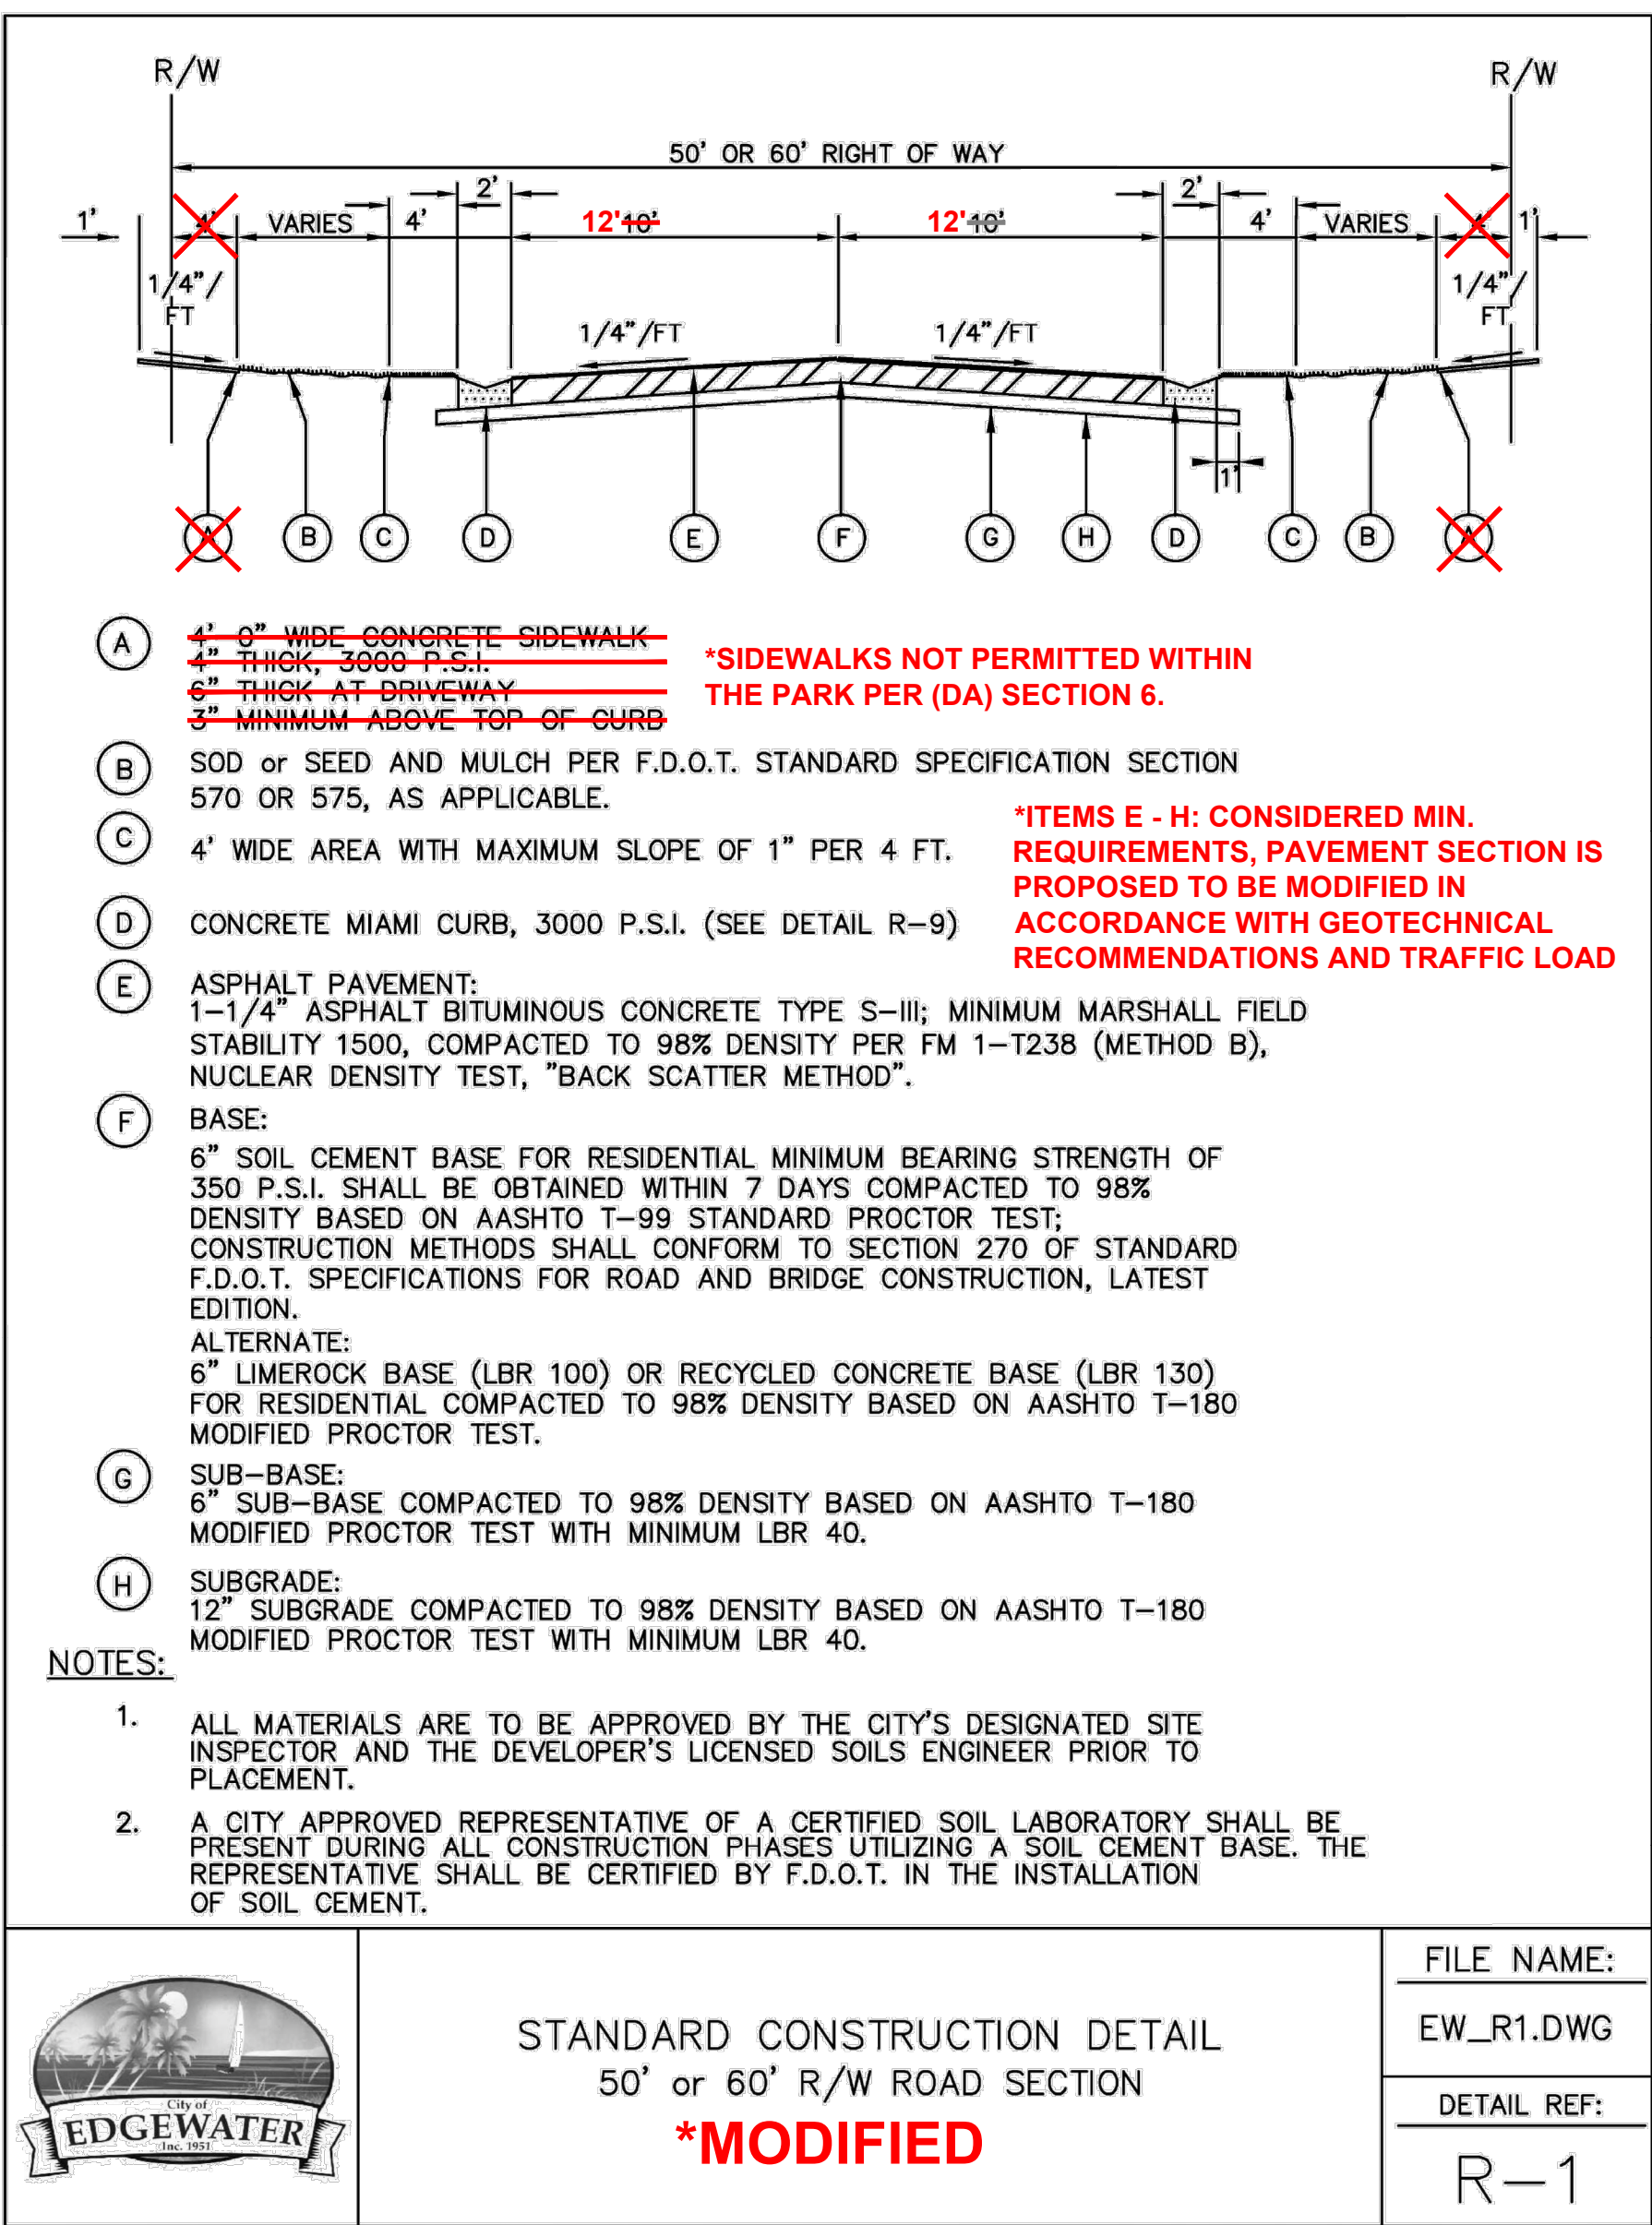

Project Name

SPACE COAST COMMERCE PARK  
@ PARKTOWNE  
CITY OF EDGEWATER, FL

Prepared For

ONIX MANAGEMENT GROUP, LLC

Project No.:

1001-002

Issued:

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ECC

Checked By:

MJS

Scale:

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Sheet Title

MASTER  
DEVELOPMENT  
SITE DETAILS

Sheet Number

C-07

Seal

MICHAEL J. SANDERS, JR., P.E.  
License Number 78918







- SANITARY SEWER DESIGN AND CONSTRUCTION NOTES**
- THE CITY'S ENVIRONMENTAL SERVICES DEPT. (424-2476) SHALL BE GIVEN A MINIMUM OF 48 HOURS ADVANCE NOTICE (NOT INCLUDING HOLIDAYS OR WEEKENDS) PRIOR TO BEGINNING ANY SANITARY SEWER CONSTRUCTION.
  - ALL GRAVITY SANITARY SEWER MAIN LINES SHALL BE 8" DIAMETER MINIMUM. COMMERCIAL SERVICE LATERALS WITH MULTIPLE CONNECTIONS SHALL BE GREEN 6" DIA. OR LARGER. ALL SINGLE FAMILY RESIDENTIAL SERVICE LATERALS SHALL BE 4" - SINGLE SERVICES.
  - ALL GRAVITY SANITARY SEWER LINES SHALL BE GREEN PVC SDR 26, ASTM D-3034. IN PLACES WHERE A MINIMUM COVER OF 4.0' CANNOT BE MAINTAINED, AWWA C-900 OR C-905 GREEN PVC DR-25, CLASS 100 OR CONCRETE ENCASUREMENT SHALL BE USED. WATER LINES, RECLAIMED LINES, AND STORM DRAINAGE CROSSINGS SHALL ALSO FOLLOW THE CONCRETE ENCASUREMENT REQUIREMENT PER THESE STANDARDS AND AS PER REGULATORY REQUIREMENTS.
  - MINIMUM GRAVITY SANITARY SEWER SLOPES ARE AS FOLLOWS:  
8" PIPE 0.40 %  
10" PIPE 0.30 %  
12" PIPE 0.22 %
  - GRAVITY SANITARY SEWER LINES SHALL BE INSTALLED WHENEVER POSSIBLE UNDER PAVED AREAS WITHIN PUBLIC RIGHTS-OF-WAY. UTILITY EASEMENTS SHALL BE PROVIDED WHENEVER PUBLICLY-OWNED SEWER LINES ARE CONSTRUCTED OUTSIDE OF A PUBLIC RIGHT-OF-WAY.
  - GRAVITY SANITARY SEWER LINE CONSTRUCTION SHALL BE ACCOMPLISHED BY THE USE OF A LASER INSTRUMENT UNLESS ANOTHER METHOD IS PREVIOUSLY APPROVED BY THE CITY.
  - THE CONTRACTOR SHALL AT ALL TIMES, DURING PIPE LAYING OPERATIONS, DEWATER THE GROUND SUFFICIENTLY TO KEEP THE GROUNDWATER ELEVATION A MINIMUM OF 6" BELOW THE PIPE BEING LAID WITHIN THE AREA OF THE TRENCH.
  - ALL PIPES SHALL BE LAID ON A FIRM FOUNDATION. SOFT OR SPONGY BEDDING FOR PIPES IS NOT ACCEPTABLE. ANY UNSUITABLE MATERIAL SHALL BE REMOVED AND REPLACED WITH A DRY, COMPACTED, GRANULAR MATERIAL SATISFACTORY TO THE CITY.
  - ON ALL EXCAVATION AND BACKFILLING THE CONTRACTOR SHALL PROVIDE ADEQUATE SHEETING AND BRACING IN ORDER TO PROVIDE FOR THE SAFETY OF WORKMEN, AS WELL AS REPRESENTATIVES OF THE CITY, THE DESIGN ENGINEER, AND THE DEVELOPER.
  - ALL TRENCHES SHALL BE BACKFILLED WITH ACCEPTABLE MATERIAL AND COMPACTED TO THE SPECIFIED MINIMUM COMPACTION (95% IN UNPAVED AREAS AND 98% IN PAVED AREAS) OF THE OPTIMUM DENSITY OF THAT MATERIAL BASED ON THE AASHTO T-180 MODIFIED PROCTOR TEST.
  - THE CONTRACTOR SHALL EMPLOY AN INDEPENDENT TESTING LABORATORY AT HIS OWN EXPENSE TO INSURE THAT COMPACTION OF ALL FILL MATERIAL IS COMPLETED PROPERLY. TESTS SHALL BE DONE ONE FOOT ABOVE THE PIPE AND THEN AT ONE FOOT VERTICAL INTERVALS UNTIL FINAL GRADE IS REACHED. TESTING SHALL BE COMPLETED AND TEST DOCUMENTS SUBMITTED TO THE CITY AT A MINIMUM FREQUENCY OF ONE SET OF TESTS BETWEEN EACH MANHOLE AND ONE ADDITIONAL SET OF TESTS AT EVERY MANHOLE. IDENTIFICATION OF TEST LOCATIONS SHALL BE CLEARLY INDICATED ON TEST REPORTS. TEST RESULTS SHALL BE FORWARDED PROMPTLY TO THE CITY'S DESIGNATED SITE INSPECTOR.
  - THE CONTRACTOR SHALL INSTALL A METALLIZED FOIL LOCATOR TAPE, OR SIMILAR DEVICE AS MAY BE APPROVED BY THE CITY FOR THE FULL LENGTH OF ALL PVC SEWAGE FORCE MAINS. THIS PIPE LOCATOR AID SHALL BE INSTALLED BETWEEN 15" AND 24" BELOW FINISHED GRADE OR AS DIRECTED BY THE MANUFACTURER. TAPE SHALL BE COLOR CODED GREEN FOR SANITARY SEWER AND FORCE MAIN. INSTALL 12 GAUGE TRACING WIRE IN TRENCH.

STANDARD CONSTRUCTION DETAIL  
SANITARY SEWER DESIGN AND  
CONSTRUCTION NOTES

FILE NAME:  
EW\_S23.DWG  
DETAIL REF:  
S-23

- SANITARY SEWER DESIGN AND CONSTRUCTION NOTES:  
(CONTD.)**
- ALL TESTING REQUIRED BY THE CITY SHALL BE PAID FOR BY THE CONTRACTOR / DEVELOPER.
  - ALL LOCAL COLLECTION SANITARY SEWER MANHOLES SHALL BE PRECAST WITH A MINIMUM INSIDE DIAMETER OF 4 FEET.
  - STANDARD MANHOLES SHALL BE LOCATED AT INTERVALS NOT EXCEEDING 400 FEET.
  - ALL SEWER FITTINGS TO BE "HARCO" OR CITY APPROVED EQUAL.
  - MANHOLE RIMS SHALL MATCH FLUSH WITH THE FINISH GRADE ELEVATION IN PAVED AREAS AND A MINIMUM OF 0.2 FEET AND MAXIMUM OF 0.5 FEET ABOVE GRADE GENERALLY IN UNPAVED AREAS.
  - THE CONTRACTOR SHALL CONSTRUCT SANITARY SEWER MANHOLES IN SUCH A WAY THAT SEWER LINES DO NOT INTERSECT SEALED JOINTS BETWEEN SECTIONS OF THE MANHOLE.
  - RUBBER BOOTS AND STAINLESS STEEL BANDS SHALL BE UTILIZED IN THE CONNECTION OF THE SEWER MAIN TO THE MANHOLES (SEE STANDARD MANHOLE AND BOOT DETAIL).
  - INDIVIDUAL SANITARY SERVICE CONNECTORS ON NEW CONSTRUCTION SHALL NOT BE CONNECTED DIRECTLY INTO MANHOLES, AND MUST CONNECT TO SEWER MAIN LINES BY USE OF WYE CONNECTIONS, UNLESS OTHERWISE BE APPROVED BY THE CITY.
  - FOR SINGLE FAMILY HOMES, SINGLE OR DOUBLE FOUR INCH SEWER SERVICES LATERALS SHALL BE CONSTRUCTED SINGLES AT EACH LOT OR UNIT AND LOCATED ON THE DOWNSTREAM SIDE OF THE LOT CENTER LINE. DOUBLES LOCATED ON THE LOT LINES THESE SERVICES SHALL BE EXTENDED 4 FEET ABOVE GROUND AT THE PROPERTY LINE WITH A PVC RISER AND PLUG BEING EASILY VISIBLE FROM THE ROAD. RUBBER SEAL FITTINGS SHALL BE USED ON ALL LINES. NO GLUED JOINTS ARE PERMITTED ON LATERALS, INCLUDING DOUBLES.
  - FOR MULTI-FAMILY AND COMMERCIAL SITES, SIX INCH MINIMUM SEWER SERVICES AND CLEANOUTS SHALL BE PROVIDED AS APPROVED BY THE CITY.
  - SANITARY SEWER LIFT STATIONS AND FORCE MAINS, SIZE, MATERIAL, AND DESIGNS SHALL BE APPROVED BY THE CITY. LIFT STATIONS SHALL BE CONSTRUCTED WITH A MINIMUM WET WELL INTERIOR DIAMETER OF 6 FEET. FORCE MAINS SHALL BE A MINIMUM 6 INCH DIAMETER.
  - IT SHALL BE THE RESPONSIBILITY OF THE DESIGN ENGINEER TO PREPARE AND SUBMIT FLOTATION CALCULATIONS TO SIZE THE BASE OF THE WET WELL, AND ANY MANHOLES AS DEEMED NECESSARY BY THE CITY.
  - SANITARY SEWER DROP MANHOLES SHALL ONLY BE USED UNDER SPECIAL CONDITIONS AS APPROVED BY THE CITY. DROPS LESS THAN 2.0' SHALL NOT BE ALLOWED.
  - ALL SANITARY SEWER MANHOLE COVERS SHALL HAVE THE WORDS "EDGEWATER, FLORIDA SANITARY SEWER" CAST INTO THEM.
  - ALL SANITARY SEWER FORCE MAINS, SHALL BE PVC AWWA C-900, OR C-905 (COLOR "GREEN") (PRESSURE FITTINGS, PRESSURE CLASS 150 OR 250 EPOXY LINED DIP. THE FORCE MAIN MINIMUM DEPTH OF COVER SHALL BE 36".
  - ALL SANITARY SEWER FORCE MAINS SHALL USE A THRUST RESTRAINT JOINT METHOD IN COMPLIANCE WITH THE DUCTILE IRON PIPE RESEARCH ASSOCIATION GUIDELINES MODIFIED TO ACCOMMODATE PVC PIPE BY FOLLOWING THE RECOMMENDED INCREASE IN RESTRAINT LENGTH CORRESPONDING TO THE INSTALLATION OF POLYETHYLENE WRAP. IN NO INSTANCE SHALL THRUST BLOCKS BE PERMITTED.

STANDARD CONSTRUCTION DETAIL  
SANITARY SEWER DESIGN AND  
CONSTRUCTION NOTES

FILE NAME:  
EW\_S24.DWG  
DETAIL REF:  
S-24

- SANITARY SEWER DESIGN AND CONSTRUCTION NOTES  
(CONTD.)**
- SANITARY SEWER MANHOLES WHICH HAVE SEWER FORCE MAINS DISCHARGING DIRECTLY INTO THEM SHALL BE FIBERGLASS OR POLY-ETHYLENE LINED. RETRO-FITTING OF MANHOLES WITH LINERS SHALL BE REQUIRED WHEN NEW CONNECTIONS SUCH AS THIS ARE MADE. FIBERGLASS SHALL BE A MINIMUM 1/2" THICKNESS UNLESS APPROVED OTHERWISE BY THE CITY. OTHER TYPES OF LINING METHODS AND MATERIALS MAY BE CONSIDERED ON A CASE BY CASE BASIS. UNDER SPECIAL CIRCUMSTANCES WHERE HYDROGEN SULFIDE IS A MAJOR CONCERN MANHOLES UPSTREAM AND/OR DOWNSTREAM OF THE FORCE MAIN TIE-IN OR WET WELL MAY ALSO BE REQUIRED TO HAVE LININGS INSTALLED.
  - THE CITY RESERVES THE RIGHT TO REQUIRE THE DEVELOPER TO PERFORM VACUUM TESTING OF ALL SANITARY MANHOLES, AIR TEST SEWER MAINS, AND REQUIRES THAT ALL SANITARY SEWER MAIN LINES BE TELEVIEWED PRIOR TO FINAL ACCEPTANCE. LATERALS SHALL BE TELEVIEWED UPON DEMAND BY THE CITY PRIOR TO FINAL ACCEPTANCE WHEN IT IS SUSPECTED THAT A PROBLEM EXISTS.
  - ALL SEWER MAINS, PRIOR TO ACCEPTANCE BY THE CITY AND PRIOR TO ANY FINAL PAVING OPERATIONS, SHALL BE CLEANED FLUSHED AND TELEVIEWED USING A "PAN AND TILT" CAMERA BY A CITY APPROVED CONTRACTOR. THE VIDEO SHALL BE NON-STOP WITH AUDIO DESCRIBING WHAT IS BEING REVIEWED. WRITTEN VIDEO LOGS DESCRIBING THE CONDITION OF THE LINES SHALL ACCOMPANY THE TAPE SUBMISSION TO THE CITY PRIOR TO COMMENCING ANY INSTALLATION OF ASPHALT OR CONCRETE PAVEMENT. RE-TAPING MAY BE REQUIRED BY THE CITY IF ADDITIONAL CLEARING OR CORRECTIVE ACTIONS ARE NECESSARY.
  - ALL MANHOLES WITH FORCE MAIN CONNECTIONS SHALL BE OUTFITTED WITH EGRU LINERS OR OTHER TYPES OF LINERS APPROVED BY THE CITY. IN ADDITION, THE CITY MAY REQUIRE LINES TO BE INSTALLED IN AREAS WHERE THE ENVIRONMENTAL SERVICES DEPARTMENT BELIEVES THE NEED IS JUSTIFIED.
  - ALL SEWER LINES WHICH ARE CONSTRUCTED OUTSIDE OF PUBLIC RIGHTS-OF-WAY WITHIN SIDE YARDS, BACKYARDS, AND OTHER POORLY ACCESSIBLE AREAS SHALL BE CONSTRUCTED OF C-900 PVC. ABSOLUTELY NO USE OF PLASTIC STYRENE FITTINGS SHALL BE ALLOWED.
  - SEWER LATERAL LOCATIONS SHALL BE MARKED ALONG THE OUTSIDE OF THE CURB WITH A SAW CUT "V", OR BY A METAL TAB SET INTO THE PAVEMENT.
  - CONTEC A-2000 PVC PIPE SHALL NOT BE ALLOWED FOR USE.
  - EZ-WRAP PLASTIC, AS MANUFACTURED BY PRESS SEAL GASKET CORPORATION, SHALL BE USED ON THE OUTSIDE OF ALL MANHOLE AND WETWELL JOINTS. APPLY ONE LAYER OF 9" WRAP CENTERED ON EACH JOINT. A CITY INSPECTOR SHALL PERSONALLY INSPECT ALL JOINT SEALS PRIOR TO BACKFILLING OPERATIONS.
  - ALL PROPOSED SEWER FORCE MAINS SHALL BE FLUSHED, PRESSURE TESTED AND CLEARED FOR SERVICE IN ACCORDANCE WITH THE LATEST AWWA STANDARDS AND THE FLORIDA DEPARTMENT OF ENVIRONMENTAL PROTECTION REQUIREMENTS. THE CONTRACTOR SHALL NOTIFY THE CITY'S DESIGNATED SITE INSPECTOR WHO SHALL COORDINATE WITH CITY PERSONNEL AT THE ENVIRONMENTAL SERVICES DEPARTMENT (AS APPROPRIATE) AT LEAST 24 HOURS PRIOR TO BEGINNING A FULL-DIAMETER FLUSH OF THE MAINS PRIOR TO THE COMMENCEMENT OF PRESSURE TESTING (SUBJECT TO AVAILABILITY).
  - THE CITY MAY REQUIRE THE CONTRACTOR TO PIG FORCE MAINS IN EXCESS OF 6" IN DIAMETER AND PRIMARY TRANSMISSION MAINS LOCATED ON COLLECTOR AND ARTERIAL ROADWAYS. LAUNCHING AND EXTRACTION POINTS SHALL BE DETERMINED BY THE CONTRACTOR.


STANDARD CONSTRUCTION DETAIL  
SANITARY SEWER DESIGN AND  
CONSTRUCTION NOTES

FILE NAME:  
EW\_S25.DWG  
DETAIL REF:  
S-25

- SANITARY SEWER DESIGN AND CONSTRUCTION NOTES  
(CONTD.)**
- ANY TIE INTO AN EXISTING MANHOLE WILL BE COORDINATED WITH THE CITY, AND ALL CONFINED SPACE HAZARDS AND PROCEDURES WILL BE FOLLOWED.
  - ANY TIE INTO AN EXISTING SYSTEM WILL BE SWEEPED IN THE DIRECTION OF FLOW.
  - THE CONTRACTOR WILL BE RESPONSIBLE FOR ALL OSHA, DOT, OR ANY OTHER RULES & REGULATIONS THAT MAY APPLY.
  - AS A GENERAL RULE, THE NUMBER OF JOINTS SHALL BE LIMITED WHENEVER POSSIBLE. IN SPECIAL CASES WHERE A POINT REPAIR TO AN 8" TO 12" PVC SEWER MAIN IS REQUIRED, THE PROPER RIGID WRAP AROUND SLEEVE SUCH AS A JCM-210 OVERSIZED DUCTILE IRON COUPLING OR AN APPROVED EQUAL MAY BE ALLOWED BY SPECIAL APPROVAL BY THE CITY.
  - ALL IN-LINE SANITARY SEWER FORCE MAIN VALVES SHALL BE RESILIENT SEAT (AWWA C-509) VALVES FEATURING A LINED DUCTILE IRON BODY.
  - ALL TAPPING OF MAINS AND CORING OF MANHOLES SHALL BE COORDINATED WITH THE CITY BY AN APPROVED CONTRACTOR AND BILLED IN ACCORDANCE WITH THE ADOPTED FEE RESOLUTION. SCHEDULING OF THESE CONNECTIONS SHALL REQUIRE A MINIMUM 48 HOUR NOTIFICATION (MEASURED ON NORMAL WORK DAYS) DIRECTED TO THE CITY'S DESIGNATED SITE INSPECTOR WHO SHALL COORDINATE THE WORK DIRECTLY WITH THE ENVIRONMENTAL SERVICE DEPARTMENT. SUBSEQUENTLY, THE CONNECTION SHALL BE SCHEDULED TO COMMENCE ON THE APPROPRIATE DAY AND TIME ESTABLISHED BY CITY.
  - WITH RESPECT TO TIE-IN CONNECTIONS AND CORING OPERATIONS, THE CITY RESERVES THE RIGHT TO REQUIRE CONNECTIONS TO BE PERFORMED DURING PERIODS OF LOW FLOW (MIDNIGHT TO 6:00 A.M.) IN ORDER TO MINIMIZE SERVICE DISRUPTION TO EXISTING CUSTOMERS.
  - ALL WORK PERFORMED UPON SANITARY SEWER FACILITIES OWNED OR PROPOSED TO BE OWNED BY THE CITY SHALL BE CONSTRUCTED BY A LICENSED UNDERGROUND UTILITY CONTRACTOR, OR LICENSED GENERAL CONTRACTOR, WHO IS LICENSED IN THE STATE OF FLORIDA AND REGISTERED WITH THE CITY.
  - UPON CONSTRUCTION COMPLETION AND ACCEPTANCE OF THE SYSTEM, IT SHALL BE THE DESIGN ENGINEER'S RESPONSIBILITY TO ENSURE THAT THE SYSTEM IS PROPERLY CERTIFIED AND ACCEPTED BY THE FLORIDA DEPARTMENT OF ENVIRONMENTAL PROTECTION AND AS-BUILTS ARE PROVIDED TO THE CITY PRIOR TO ANY USE OF THE SYSTEM.
  - FOR CONSTRUCTION PURPOSES, THE PLANS SHALL DIMENSION THE LOCATION, OF ALL FORCE MAINS MEASURED FROM THE BACK OF CURB ( OR EDGE OF PAVEMENT, IF NO CURBING EXISTS. )
  - ALL HDPE PIPE INSTALLED FOR SEWAGE FORCE MAINS SHALL BE SDR 11 UNLESS SPECIFICALLY NOTED OTHERWISE. THE HDPE PIPE SHALL BE SIZED TO MATCH THE EXTERNAL DIAMETER OF THE PVC OR DIP TO WHICH IT IS ATTACHED.
  - LANDSCAPE PLANS SHALL CLEARLY DEPICT THE DESIGN LOCATION OF PLANTINGS RELATIVE TO THE LOCATION OF PUBLIC UTILITIES AND STORMWATER INFRASTRUCTURE IN ORDER TO EVALUATE POTENTIAL CONFLICTS.
  - ALL UTILITY INSTALLATIONS ARE SUBJECT TO REVIEW AND APPEAL BY THE CITY OF EDGEWATER. ALL STRUCTURES AND EQUIPMENT SUPPLIED AND/ OR INSTALLED SHALL MEET QUALITY AND PERFORMANCE STANDARDS PRIOR TO ACCEPTANCE. SUBSTANDARD INSTALLATIONS MAY BE REJECTED, REMEMBER MEASURES ARE SUBJECT TO CITY APPROVAL.

STANDARD CONSTRUCTION DETAIL  
SANITARY SEWER DESIGN AND  
CONSTRUCTION NOTES


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EW\_S26.DWG  
DETAIL REF:  
S-26

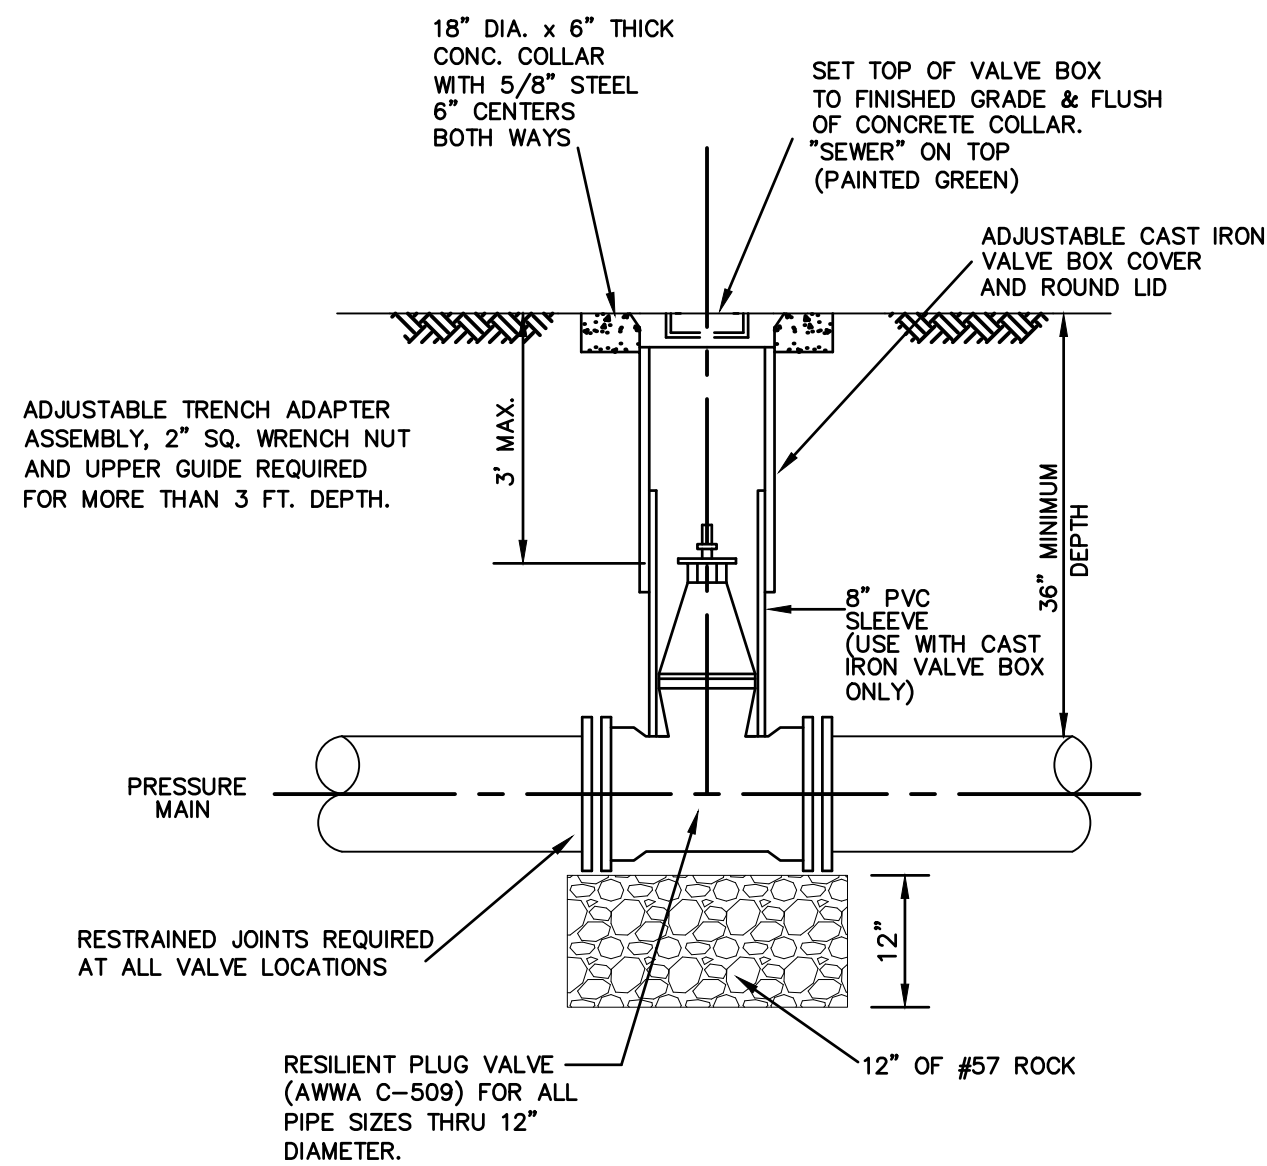

- NOTE:**
- ROD OR BOLT TO TEE WHERE APPLICABLE.

STANDARD CONSTRUCTION DETAIL  
SANITARY SEWER FORCE MAIN VALVE & VALVE BOX


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DETAIL REF:  
S-27

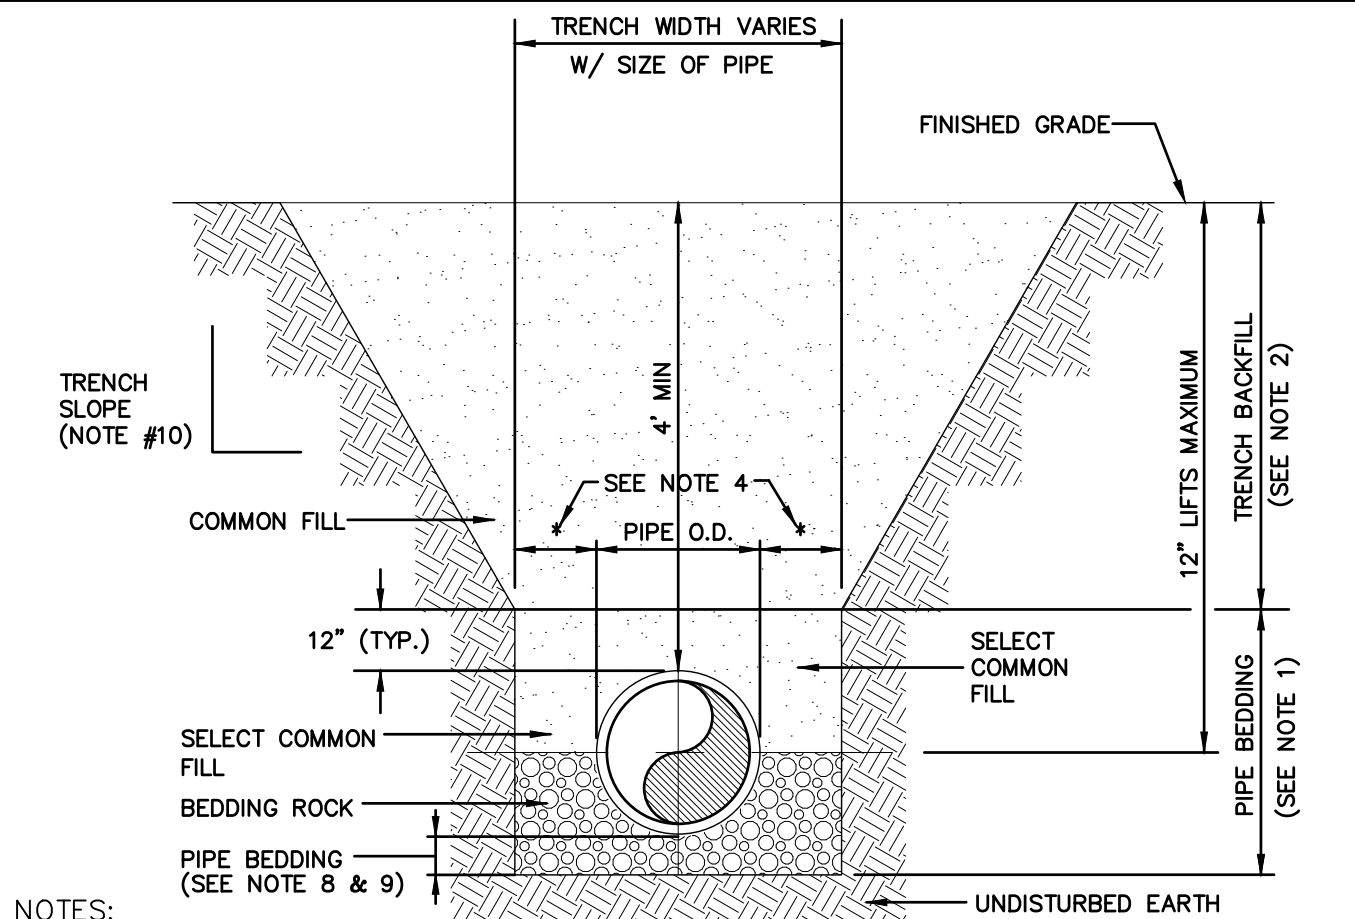

- NOTES:**
- PIPE BEDDING: SELECT COMMON FILL COMPACTED TO 95% OF THE MAXIMUM DENSITY AS PER AASHTO T-180.
  - TRENCH BACKFILL: COMMON FILL COMPACTED TO 95% OF THE MAXIMUM DENSITY AS PER AASHTO T-180. (98% DENSITY REQUIRED UNDER PAVEMENT, DRIVEWAYS AND STRUCTURES.)
  - USE TYPE "A" BEDDING TO BE DETERMINED IN THE FIELD AS DIRECTED BY THE CITY.
  - (+): 15" MAX. FOR PIPE DIAMETER LESS THAN 24", AND 24" MAX. FOR PIPE DIAMETER 24" AND LARGER.
  - WATER SHALL NOT BE PERMITTED IN THE TRENCH DURING CONSTRUCTION.
  - ALL PIPE TO BE INSTALLED WITH BELL FACING UPSTREAM TO THE DIRECTION OF FLOW.
  - REFER TO SECTION 32.5 OF THE MANUAL FOR SHEETING AND BRACING IN EXCAVATIONS.
  - GRAVITY SEWERS SHALL UTILIZE TYPE "A" BEDDING, WHERE UNSUITABLE MATERIAL EXISTS. BEDDING DEPTH SHALL BE 4" MINIMUM FOR PIPE DIAMETER LESS THAN 15", AND 6" MINIMUM FOR PIPE DIAMETER 16" AND LARGER.
  - DEPTH FOR REMOVAL OF UNSUITABLE MATERIAL SHALL GOVERN DEPTH OF BEDDING ROCK BELOW THE PIPE. CITY SHALL DETERMINE IN THE FIELD REQUIRED REMOVAL OF UNSUITABLE MATERIAL TO REACH SUITABLE FOUNDATION.
  - REFER TO OSHA REQMTS. FOR SLOPING, SHEETING AND BRACING IN EXCAVATIONS.

STANDARD CONSTRUCTION DETAIL  
TYPE "A" BEDDING AND TRENCH DETAIL  
(SPECIAL GRAVITY SEWER INSTALLATIONS)

FILE NAME:  
EW\_S28.DWG  
DETAIL REF:  
S-28

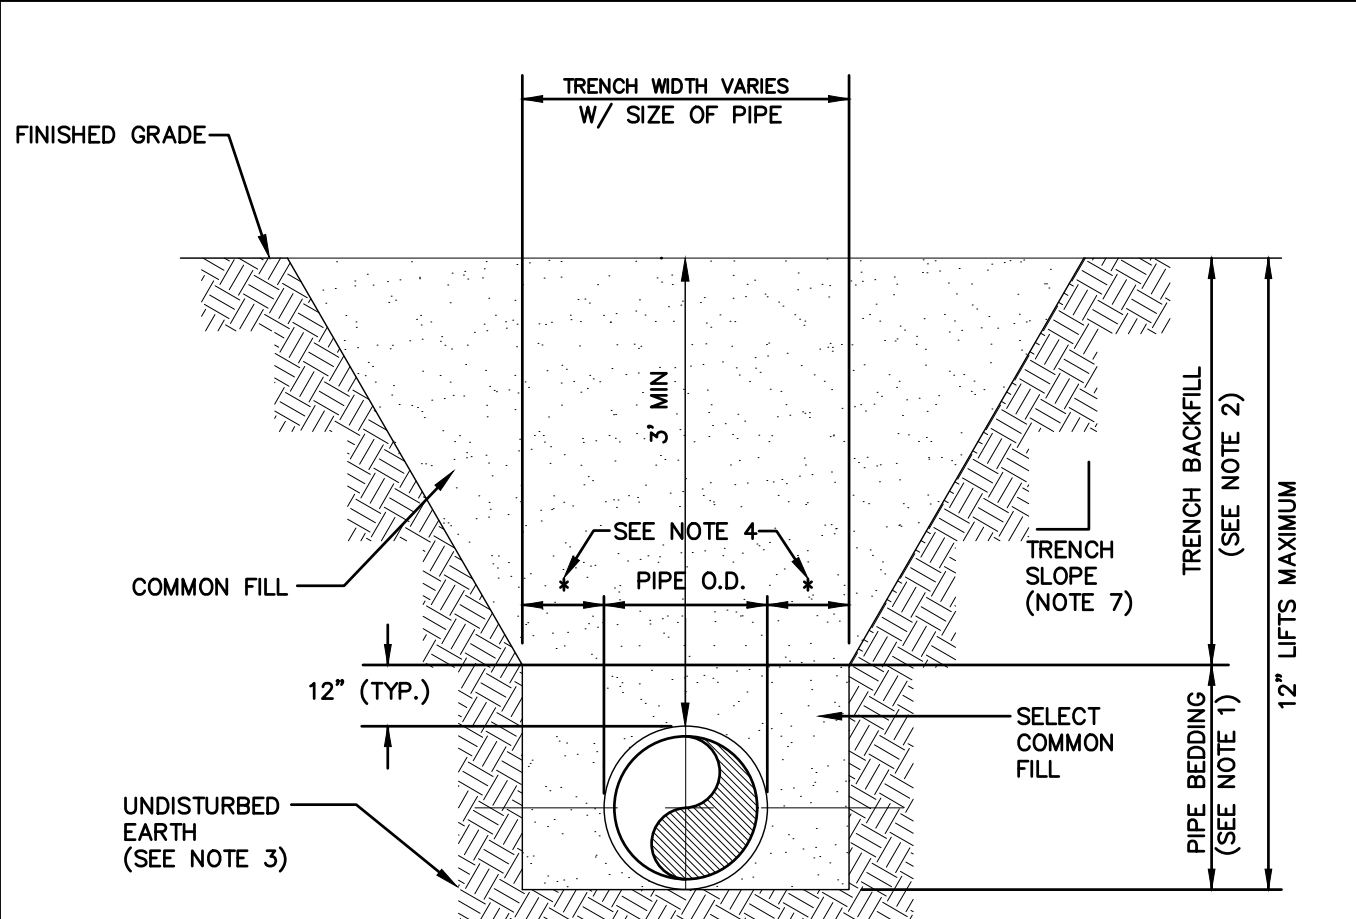

- NOTES:**
- PIPE BEDDING: SELECT COMMON FILL COMPACTED TO 95% OF THE MAXIMUM DENSITY AS PER AASHTO T-180.
  - TRENCH BACKFILL: COMMON FILL COMPACTED TO 95% OF THE MAXIMUM DENSITY AS PER AASHTO T-180, (98% DENSITY REQUIRED UNDER DRIVEWAYS, PAVEMENT AND STRUCTURES).
  - PIPE BEDDING UTILIZING SELECT COMMON FILL OR BEDDING ROCK IN ACCORDANCE WITH TYPE "A" BEDDING AND TRENCHING DETAIL MAY BE REQUIRED AS DIRECTED BY THE CITY.
  - (+): 15" MAX. FOR PIPE DIAMETER LESS THAN 24", AND 24" MAX. FOR PIPE DIAMETER 24" AND LARGER.
  - WATER SHALL NOT BE PERMITTED IN THE TRENCH DURING CONSTRUCTION.
  - ALL PIPE TO BE INSTALLED WITH BELL FACING UPSTREAM TO THE DIRECTION OF FLOW.
  - REFER TO OSHA REQUIREMENTS FOR SLOPING, SHEETING AND BRACING IN EXCAVATIONS.
  - FINAL RESTORATION IN IMPROVED AREAS SHALL BE IN COMPLIANCE WITH ALL APPLICABLE REGULATIONS OF GOVERNING AGENCIES. SURFACE RESTORATION WITHIN RIGHT-OF-WAY SHALL COMPLY WITH REQUIREMENTS OF RIGHT-OF-WAY UTILIZATION REGULATIONS AND ROAD CONSTRUCTION SPECIFICATIONS.

STANDARD CONSTRUCTION DETAIL  
TYPE "B" BEDDING AND TRENCH DETAIL  
(TYPICAL FOR WATER, SEWER, FORCE MAIN, STORM  
DRAIN AND RECLAIMED WATER MAIN INSTALLATIONS)

FILE NAME:  
EW\_S29.DWG  
DETAIL REF:  
S-29

Project Name

SPACE COAST COMMERCE PARK  
@ PARKTOWNE

City of Edgewater, FL

Prepared For

ONICX MANAGEMENT GROUP, LLC

4206 NATIONAL GUARD DRIVE, #1  
PLANT CITY, FL 33563  
Phone (813) 867-7024 Web www.oxboweng.com  
FL Registry 36174

| Revision | No. | Date | Description |
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Seal

MICHAEL J. SANDERS, JR., P.E.  
License Number 78918

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| Project No.: | 1001-002     |
| Issued:      | AUG 21, 2023 |
| Drawn By:    | ECC          |
| Checked By:  | MJS          |
| Scale:       | 1" = N/A     |

Sheet Title

**MASTER  
DEVELOPMENT COE  
SEWER DETAILS**

Sheet Number



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
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Project Name  
SPACE COAST COMMERCE PARK  
@ PARKTOWNE  
CITY OF EDGEWATER, FL

Prepared For  
ONICX MANAGEMENT GROUP, LLC



4206 NATIONAL GUARD DRIVE, #1  
PLANT CITY, FL 33563  
Phone (813) 857-7024 Web www.oxboweng.com  
FL Registry 36174 FL L22000260419

| Revision No. | Date | Description |
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Seal  

MICHAEL J. SANDERS, JR., P.E.  
License Number 72910

Project No.: 1001-002  
Issued: AUG 21, 2023  
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DEVELOPMENT COE  
WATER DETAILS

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
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| Project Name<br>SPACE COAST COMMERCE PARK<br>@ PARKTOWNE<br>CITY OF EDGEWATER, FL   |      | Prepared For<br>ONICX MANAGEMENT GROUP, LLC           |  |
| <div><div>4206 NATIONAL GUARD DRIVE, #1<br/>PLANT CITY, FL 33563<br/>Phone (813) 857-7024 Web www.oxboweng.com<br/>FL Registry 36174 FL L22000260419</div></div> |      |   |  |
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| <div><div>Project No.: 1001-002</div><div>Issued: AUG 21, 2023</div><div>Drawn By: ECC</div><div>Checked By: MJS</div><div>Scale: 1" = N/A</div><div>Sheet Title<br/>MASTER DEVELOPMENT COE<br/>WATER DETAILS</div><div>Sheet Number</div></div>    |      |   |  |

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